


CAMPUS SITE PLAN

SCALE: 1" = 60'

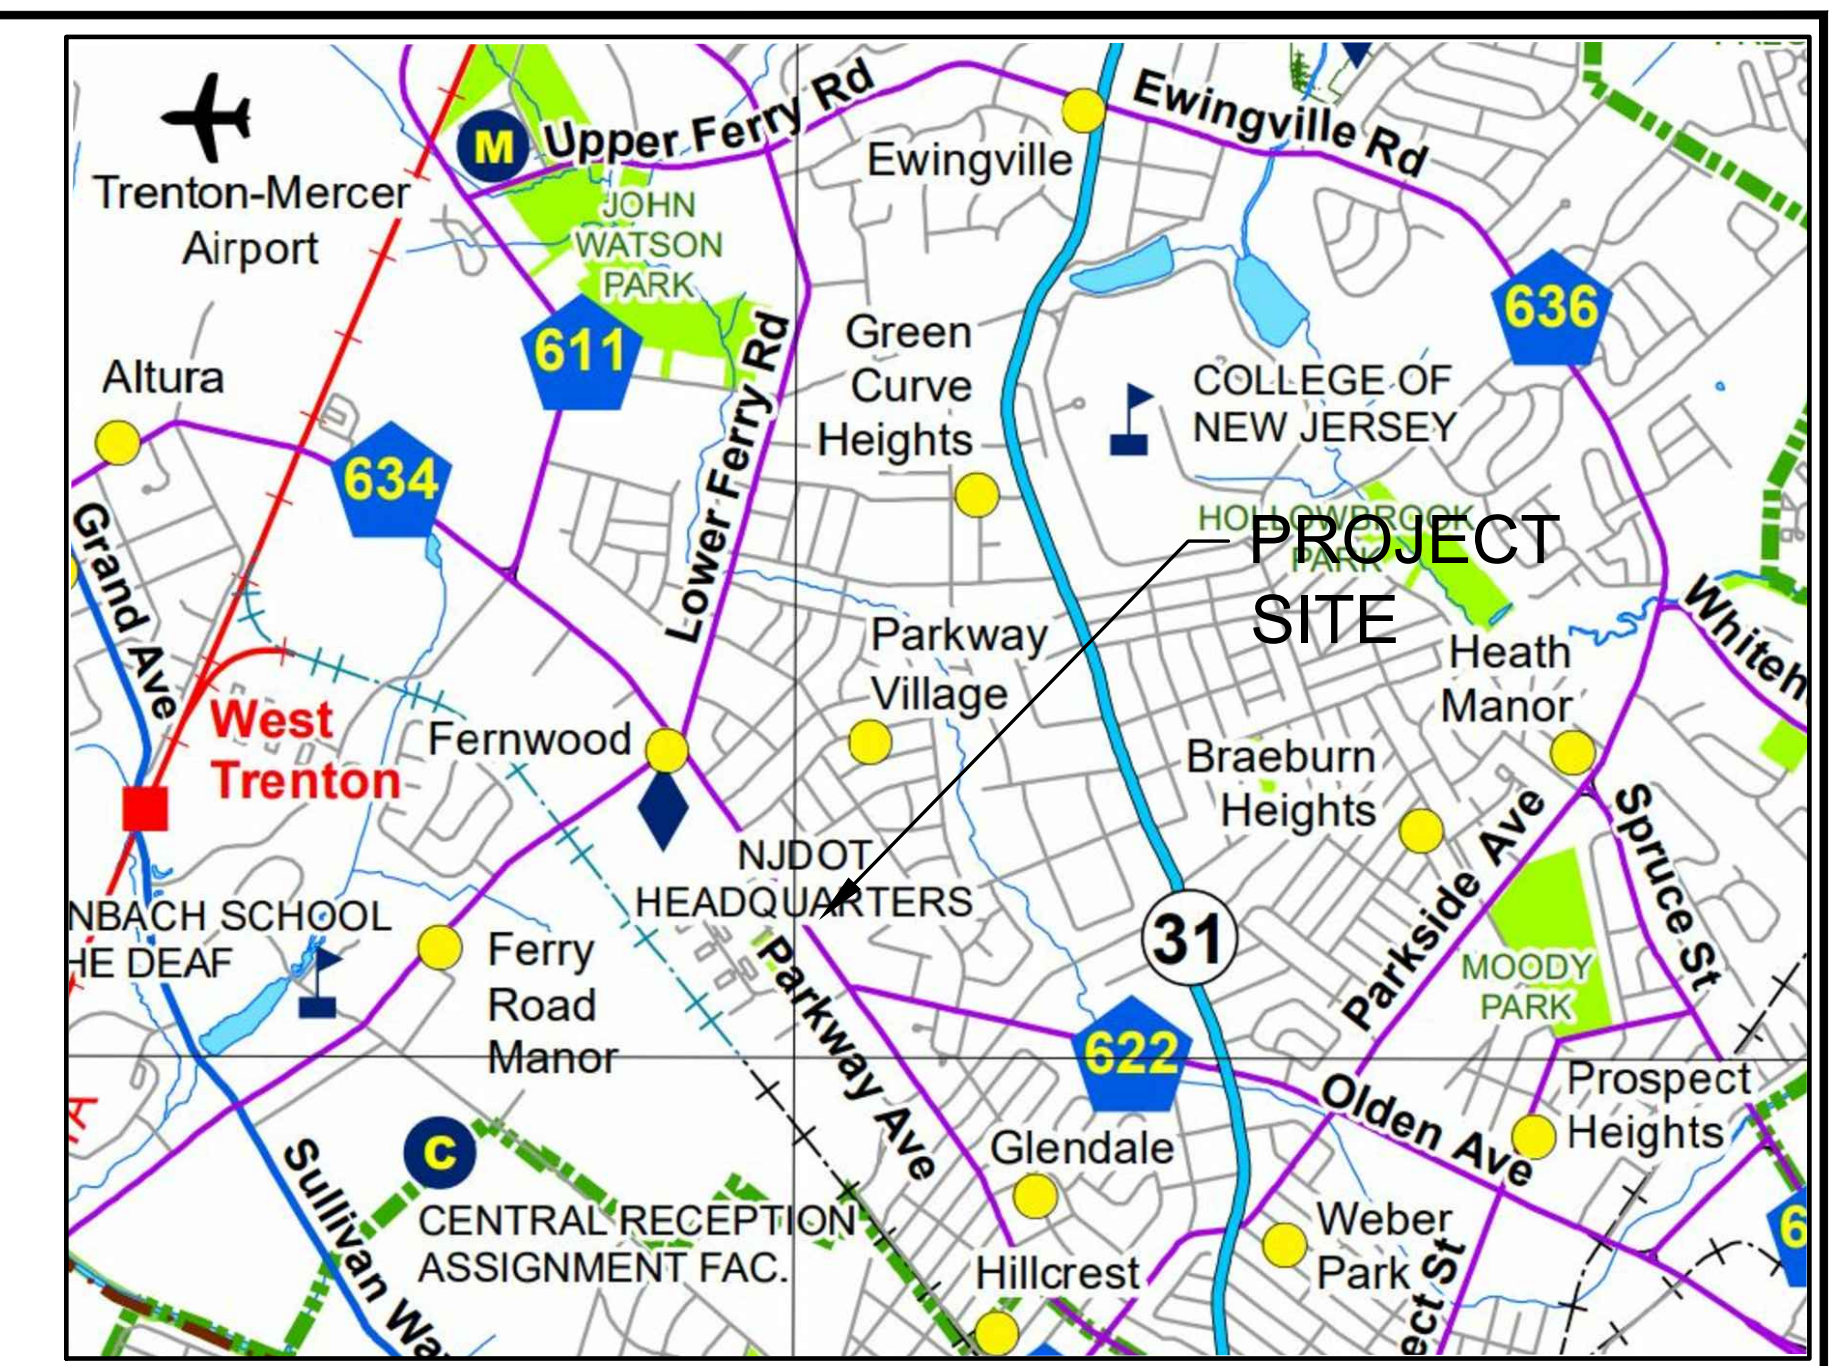

KEY MAP

SCALE: 1" = 2000'

- GENERAL NOTES
1. THE SUBJECT PARCEL IS IDENTIFIED AS THE EWING HIGH SCHOOL WITH STREET FRONTAGE ALONG PARKWAY AVENUE & GLEN MAWR AVENUE IN THE TOWNSHIP OF EWING, MERCER COUNTY, NJ
 2. THE PROPERTY IS KNOWN AS BLOCK 487, LOT 86 AS SHOWN ON TAX MAP BOOK SHEETS # 42 AND #104.
 3. THE PROJECT IS LOCATED WITHIN THE R-2 SINGLE FAMILY RESIDENTIAL (DETACHED) ZONING DISTRICT PER THE "ZONING BOUNDARY MAP OF THE TOWN OF EWING".
 4. THE PROPERTY IS LOCATED WITHIN "ZONE X", AREA OF MINIMAL FLOODING", PER THE FEMA FIRM MAP #34021C0118F, EFFECTIVE DATE JULY 2016.
 5. THE HORIZONTAL DATUM AND BEARING SYSTEM IS BASED UPON THE NEW JERSEY STATE PLANE COORDINATE SYSTEM, NAD83 (2011) (EPOCH: 2010). THE VERTICAL DATUM IS BASED UPON NAVD83. BOTH DATUMS WERE ESTABLISHED BY TAKING STATIC GPS OBSERVATIONS ON KNOWN SURVEY CONTROL POINTS AND SUBMITTING THE DATA TO OPUS RS FOR POST-PROCESSING.
 6. THE PHYSICAL SITE CONDITIONS REPRESENTED ON THIS PLAN ARE AS THEY APPEARED AT THE TIME OF THE FIELD SURVEY BY EDWARDS ENGINEERING GROUP INC., IN MAY 2022. LOCALIZED TOPOGRAPHIC SURVEYS WERE CONDUCTED WITHIN PROPOSED WORK AREAS. OTHER TOPOGRAPHIC INFORMATION SHOWN ON THIS PLAN WAS OBTAINED FROM THE SCHOOL DISTRICT'S RECORD MAPPING.
 7. PROPERTY BOUNDARY INFORMATION DEPICTED ON THIS MAP IS BASED UPON THE SCHOOL DISTRICT'S RECORD MAPPING OF A 2019 CONSTRUCTION PROGRAM, PREPARED BY PENNONI ASSOCIATES. AN UPDATED PROPERTY BOUNDARY SURVEY WAS NOT PERFORMED AS PART OF THIS PROJECT AND PROPERTY LINES APPEARING ON THIS PLAN SHALL BE CONSIDERED APPROXIMATE.

- PROJECT DESCRIPTION:
1. THE SCHOOL DISTRICT PROPOSES THE CONSTRUCTION OF A COMMEMORATIVE PLAZA ADJACENT TO THE MAIN FOOTBALL STADIUM & RUNNING TRACK, AND A NEW OUTDOOR PICNIC PAVILION ADJACENT TO THE SCHOOL BUILDING. A THIRD COMPONENT OF THIS PROJECT INVOLVES THE RELOCATION OF AN EXISTING FLAG POLE WITH LIGHTING. ALL AREAS BEING REDEVELOPED ARE CURRENTLY OPEN LAWN.
 2. A SMALL STORM WATER MANAGEMENT BASIN IS PROPOSED TO CONTROL STORM WATER RUNOFF FROM THE PROJECT AREAS. THE DESIGN OF THE STORM WATER MANAGEMENT SYSTEM IS IN FULL COMPLIANCE WITH NJ STATE STORM WATER MANAGEMENT REGULATIONS.

LEGEND OF SYMBOLS & ABBREVIATIONS

EXISTING	PROPOSED	ITEM	EXISTING	PROPOSED	ITEM
lowercase text	UPPERCASE TEXT	TEXT & NOTES	---	---	PAVEMENT EDGE
○	●	MANHOLE- NEW/RECONSTRUCT	▨	▨	STANDARD DUTY PAVEMENT
□	■	INLET- NEW/RECONSTRUCT	▩	▩	HEAVY DUTY PAVEMENT
○	○	CLEANOUT	---	---	CURB/DEPRESSED CURB
○	○	ROOF LEADER	---	---	PORTLAND CEMENT CONCRETE 6" THK, PER DETAIL 3/C-6
○	○	VALVE-TYPE	---	---	TREE/WOOD LINE
○	○	FIRE HYDRANT/FDC	---	---	BUSH/SHRUBS
○	○	UTIL. POLE/W-LIGHT/W-TRANSF.	---	---	EVERGREEN/DECIDUOUS TREES
○	○	STREET/TRAFFIC SIGNS	---	---	CONTOUR LINE
○	○	LIGHTS	---	---	SPOT ELEVATIONS
○	○	FENCE	---	---	
○	○	TEMP. CONSTRUCTION FENCE 6TH CHAIN LINK PER SPEC.	---	---	
○	○	FULL-DEPTH DEMOLITION	---	---	
○	○	HAND HOLE - ELEC/DATA	---	---	

ABBREVIATIONS

ADA APPROX	AMERICAN DISABILITIES ACT APPROXIMATE	G	GAS PIPE LINE	RCP	REINFORCED CONC. PIPE
BF	BARRIER FREE	GRT	GRATE (ELEVATION)	RL	ROOF LEADER
BC	BOTTOM OF CURB REVEAL	GV	GAS VALVE	RLUG	ROOF LEADER UNDERGROUND
BIT	BITUMINOUS	HC	HANDICAPPED HIGH POINT	SCD	SOIL CONSERVATION DISTRICT
BW	BOTTOM WALL (GRADE)	HP	HIGH POINT	ST	STORM SEWER PIPE
C	CONDUIT	HYD	FIRE HYDRANT	SS/SAN	SANITARY SEWER PIPE
COMM	DATA/COMMUNICATION CABLE	INV	INVERT (ELEV.)	TEL	TELEPHONE
CONF.	CONFIGURATION	IT	INSIDE TRACK EDGE	TEL	TOP OF BORDER
CF	CHAIN LINK FENCE	LF	LINEAR FEET	TBR	TO BE REMOVED
C.O.	CLEAN OUT	LP	LOW POINT	TC	TOP OF CURB
CONC	CONCRETE	MH	MANHOLE	TP	TEST PIT
DC	DEPRESSED CURB	NIC	NOT IN CONTRACT	TRNSF	TRANSFORMER
DEMO	DEMOLITION	O/H	OVERHEAD	TW	TOP OF WALL
DI	DUCTILE IRON PIPE	O/T	OUTSIDE TRACK EDGE	TYP	TYPICAL
DS	DOWN SPOUT	E	ELECTRIC	U/G	UNDERGROUND
E	ELECTRIC	EX	EXISTING	UP	UTILITY POLE
ELEV	ELEVATION (FT.)	PC	POINT OF CURVE	V.F.	VERIFY IN FIELD
EX	EXISTING	PCC	POINT OF COMPOUND CURVE	W.F.	WATER
FDC	FIRE DEPT. CONN.	PEP	POLYETHYLENE PIPE (HDPE)	WV	WATER VALVE
FM	FORCE MAIN (SEWAGE)	PROP	PROPOSED		
FO	FIBER OPTIC CABLE	PT	POINT OF TANGENT		
FTC	FOOTING	PVC	POLYVINYL CHLORIDE PIPE		

Civil Engineering Consultant: EEG 1543A

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WILLIAM B. EDWARDS, P.E.
Professional Engineer - N.J. Lic. No. GE36148

Date: 06-17-22

JOHN J. VEIZ, AIA, CSBA
WILLIAM D. HOPKINS III, AIA, LEED AP
GEORGE E. DUTHIE, JR., AIA, FP
6/16/22

EFVHD architects
planners
Fraytak Veisz Hopkins Duthie P C
1515 Lower Ferry Road - Trenton - New Jersey 08628
Corporate: 130 Whittaker Ave - Mont Clare - Pennsylvania 19453

Project Name
Commemorative Plaza at Ewing High School

Project Owner Name
Ewing Public Schools

Project Location
900 Parkway Avenue, Ewing, NJ 08618

Project Number
5410

Project Date
06/16/2022

Checked By
WBE (EEG)

Drawn By
SRP (EEG)

Scale
AS NOTED



Drawing Name
CAMPUS SITE PLAN

Revisions

No.	Date	Description

Drawing Number
C0.0

SEE DRAWING C-3.0 FOR NOTES THAT APPLY TO THIS WORK

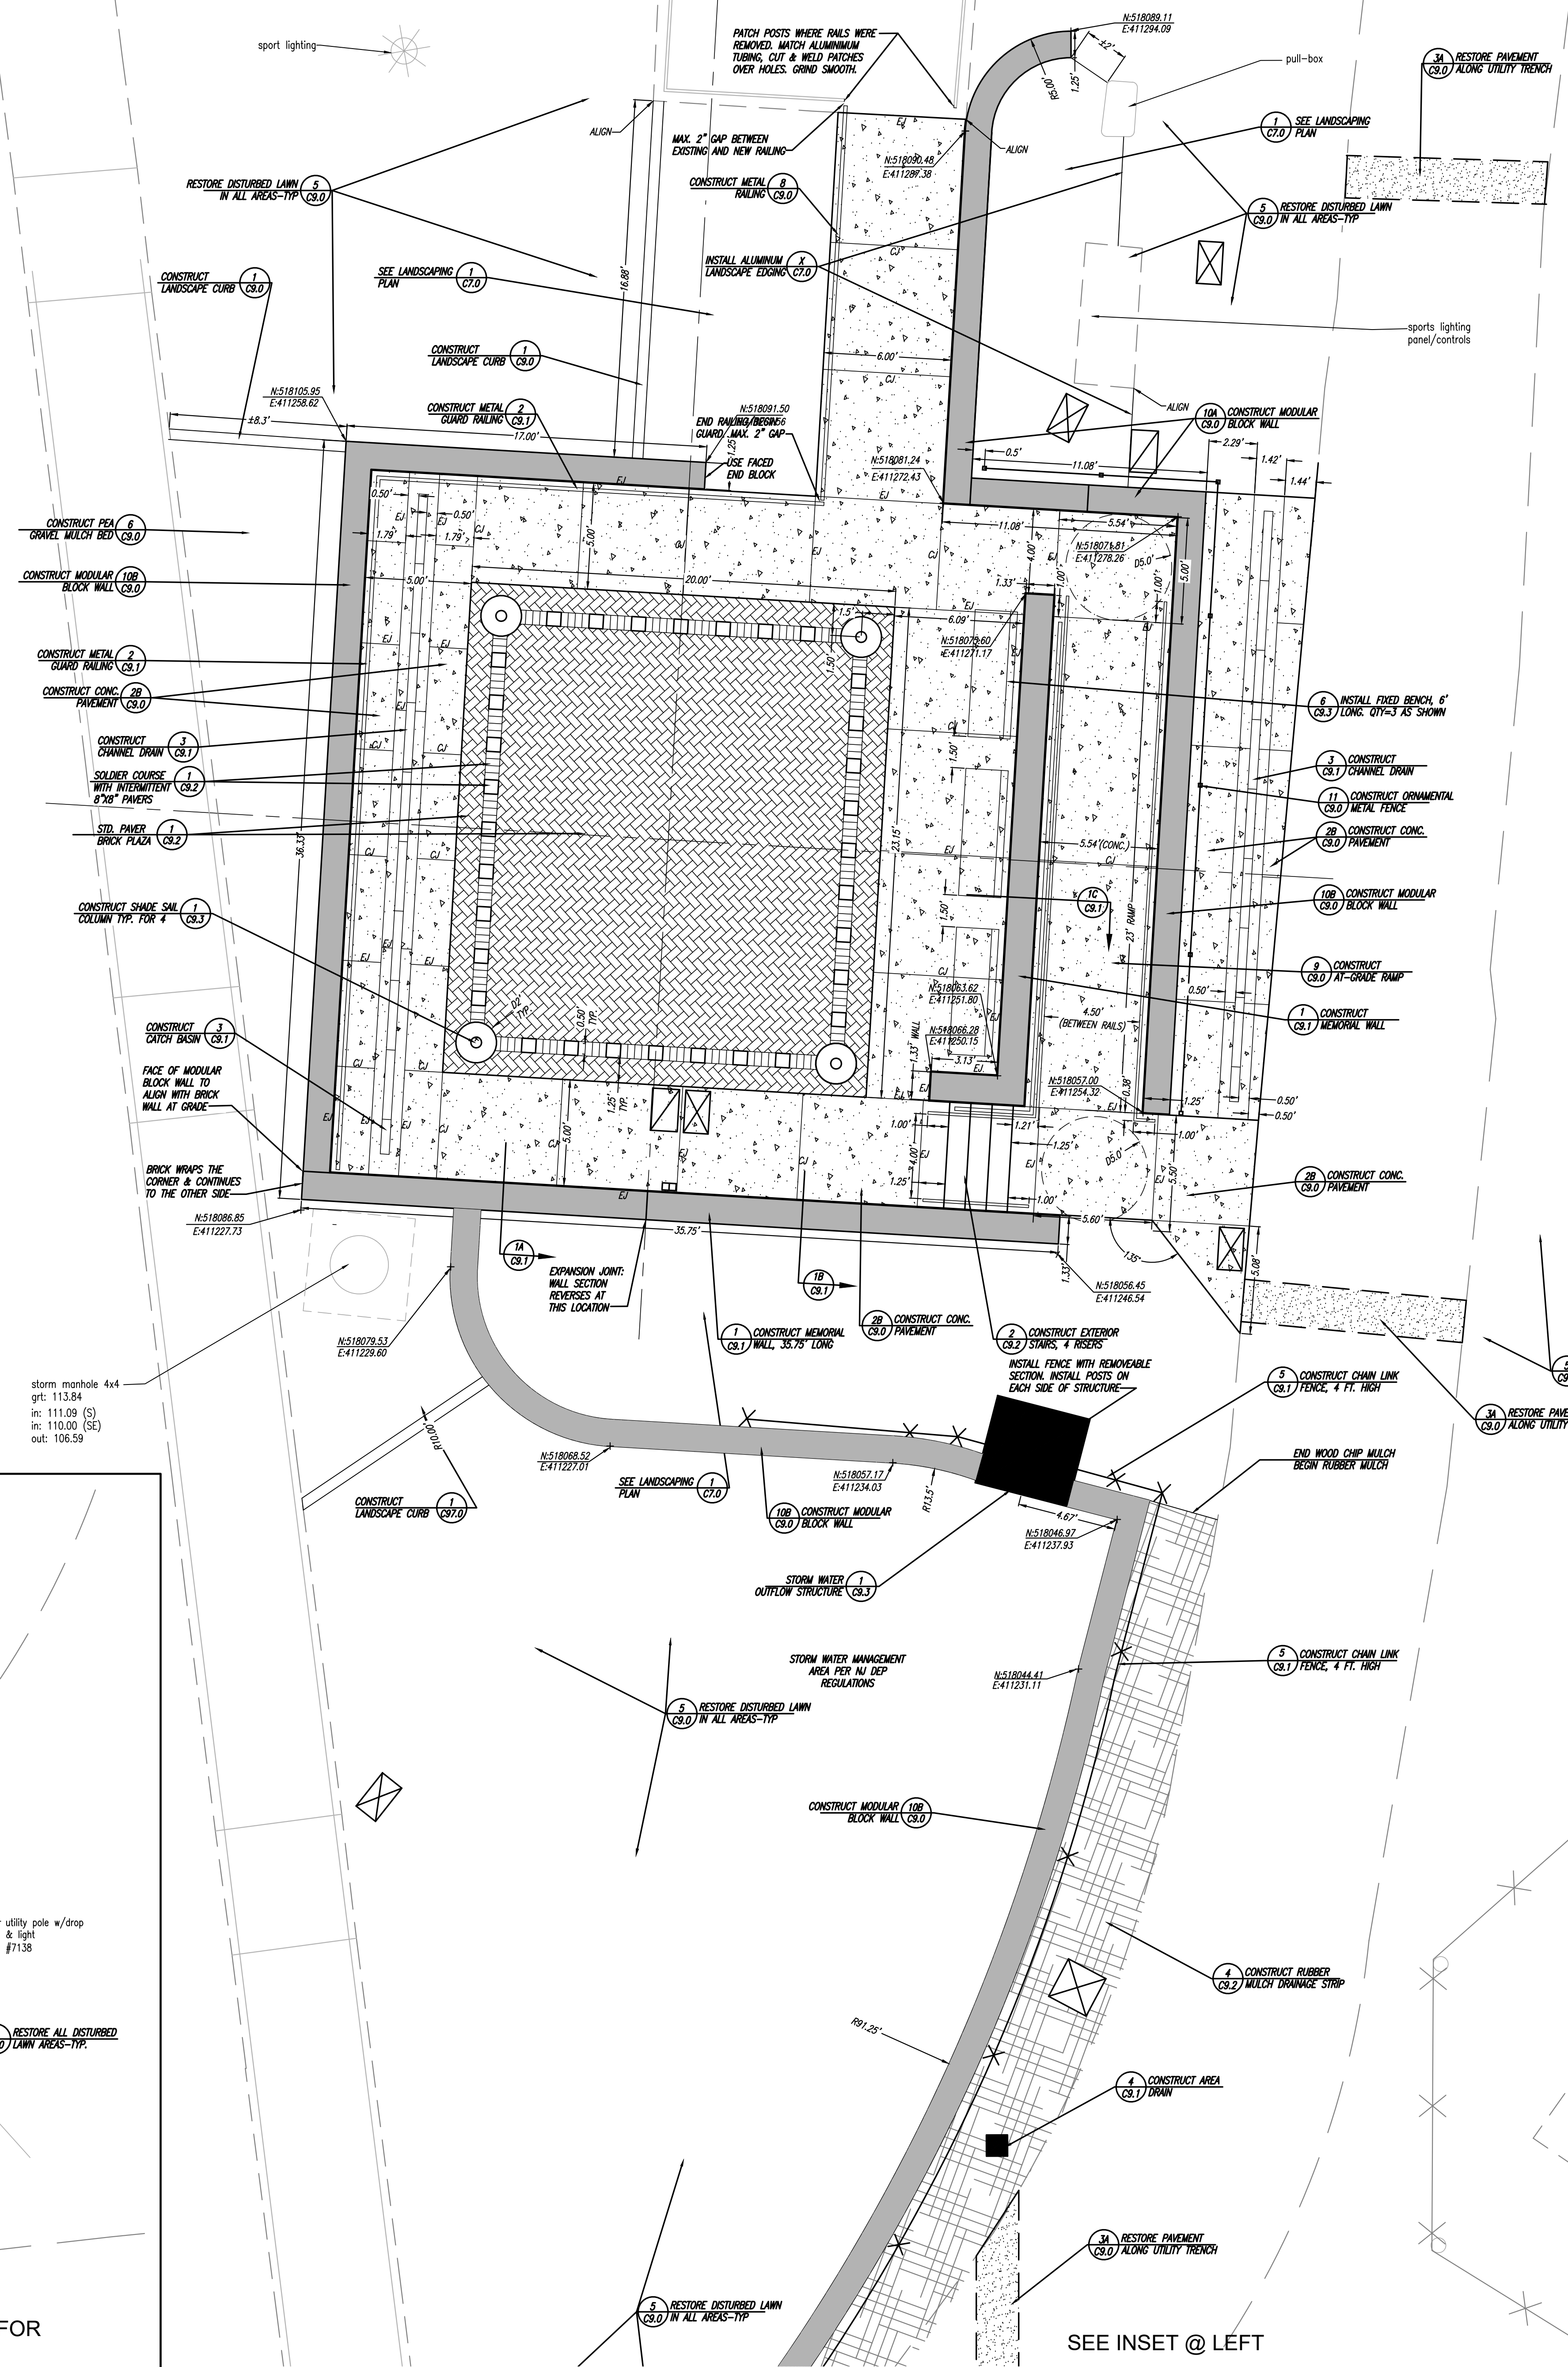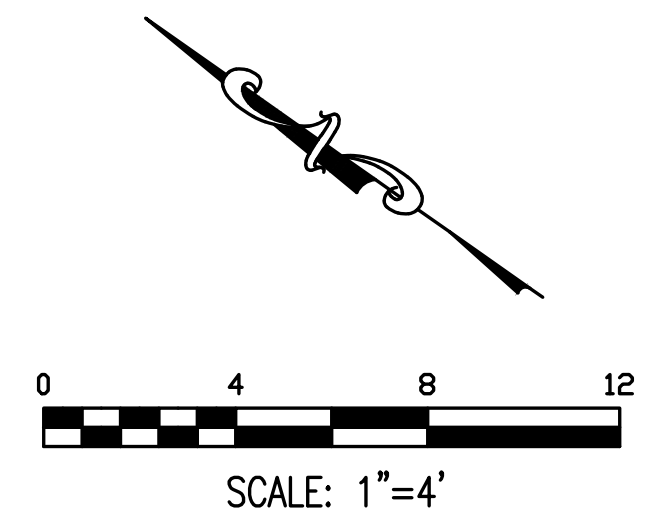


ug electric per owner records

LEGEND OF SYMBOLS & ABBREVIATIONS

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lowercase text	UPPERCASE TEXT	TEXT & NOTES	---	---	PAVEMENT EDGE
○	○	MANHOLE - NEW/RECONSTRUCT	▨	▨	STANDARD DUTY PAVEMENT
□	□	INLET - NEW/RECONSTRUCT	▩	▩	HEAVY DUTY PAVEMENT
○ c.o.	○	CLEANOUT	▩	▩	PORTLAND CEMENT CONCRETE 6" THK. PER DETAIL 3/C-6
○	○	ROOF LEADER	▩	▩	TREE/WOOD LINE
gv	gv	VALVE-TYPE	▩	▩	BUSH/SHRUBS
fw	fw	FIRE HYDRANT/FDC	▩	▩	EVERGREEN/DECIDUOUS TREES
u	u	UTIL. POLE/W-LIGHT/W-TRANSF.	▩	▩	CONTOUR LINE
st	st	STREET/TRAFFIC SIGNS	▩	▩	SPOT ELEVATIONS
l	l	LIGHTS	▩	▩	
f	f	FENCE	▩	▩	
tc	tc	TEMP. CONSTRUCTION FENCE 6'H CHAIN LINK PER SPEC.	▩	▩	
fd	fd	FULL-DEPTH DEMOLITION	▩	▩	
h	h	HAND HOLE - ELEC./DATA	▩	▩	

ABBREVIATIONS

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BT	BUTYRUS	HC	HANDICAPPED	SCD	SOIL CONSERVATION DISTRICT
BIT	BITUMINOUS	HP	HIGH POINT	ST	STORM SEWER PIPE
BW	BOTTOM WALL (GRADE)	HP	FIRE HYDRANT	SS/SAN	SANITARY SEWER PIPE
C	CONDUIT	HYD	HYDRANT		
C COMM	DATA/COMMUNICATION CABLE	INV	INVERT (ELEV.)	TEL	TELEPHONE
CONFIG	CONFIGURATION	IT	INSIDE TRACK EDGE	TB	TOP OF BORDER TO BE REMOVED
CLF	CHAIN LINK FENCE	LF	LINEAR FEET	TBR	TO BE REMOVED TOP OF CURB
C.O.	CLEAN OUT	LP	LOW POINT	TC	TEST PIT
CONC	CONCRETE	MH	MANHOLE	TRANSF	TRANSFORMER
DC	DEPRESSED CURB	NIC	NOT IN CONTRACT	TW	TOP OF WALL
DEM	DEMOLITION	O/H	OVERHEAD	TYP	TYPICAL
DIP	DIMPLE IRON PIPE	OT	OUTSIDE TRACK EDGE	U/C	UNDERGROUND UTILITY POLE
DS	DOWN SPOUT	PC	POINT OF CURVE	U.P.	UTILITY POLE
E	ELECTRIC	PCC	POINT OF COMPOUND CURVE	V.I.F.	VERIFY IN FIELD
ELEV	ELEVATION (FT.)	PEP	POLYETHYLENE PIPE (HDPE)	W	WATER
FDC	FIRE DEPT. CONN.	PROP	PROPOSED	WV	WATER VALVE
FM	FIBER MAIN (GEWAGE)	PT	POINT OF TANGENT		
FT	FIBER OPTIC CABLE	PVC	POLYVINYL CHLORIDE PIPE		
FTG.	FOOTING				

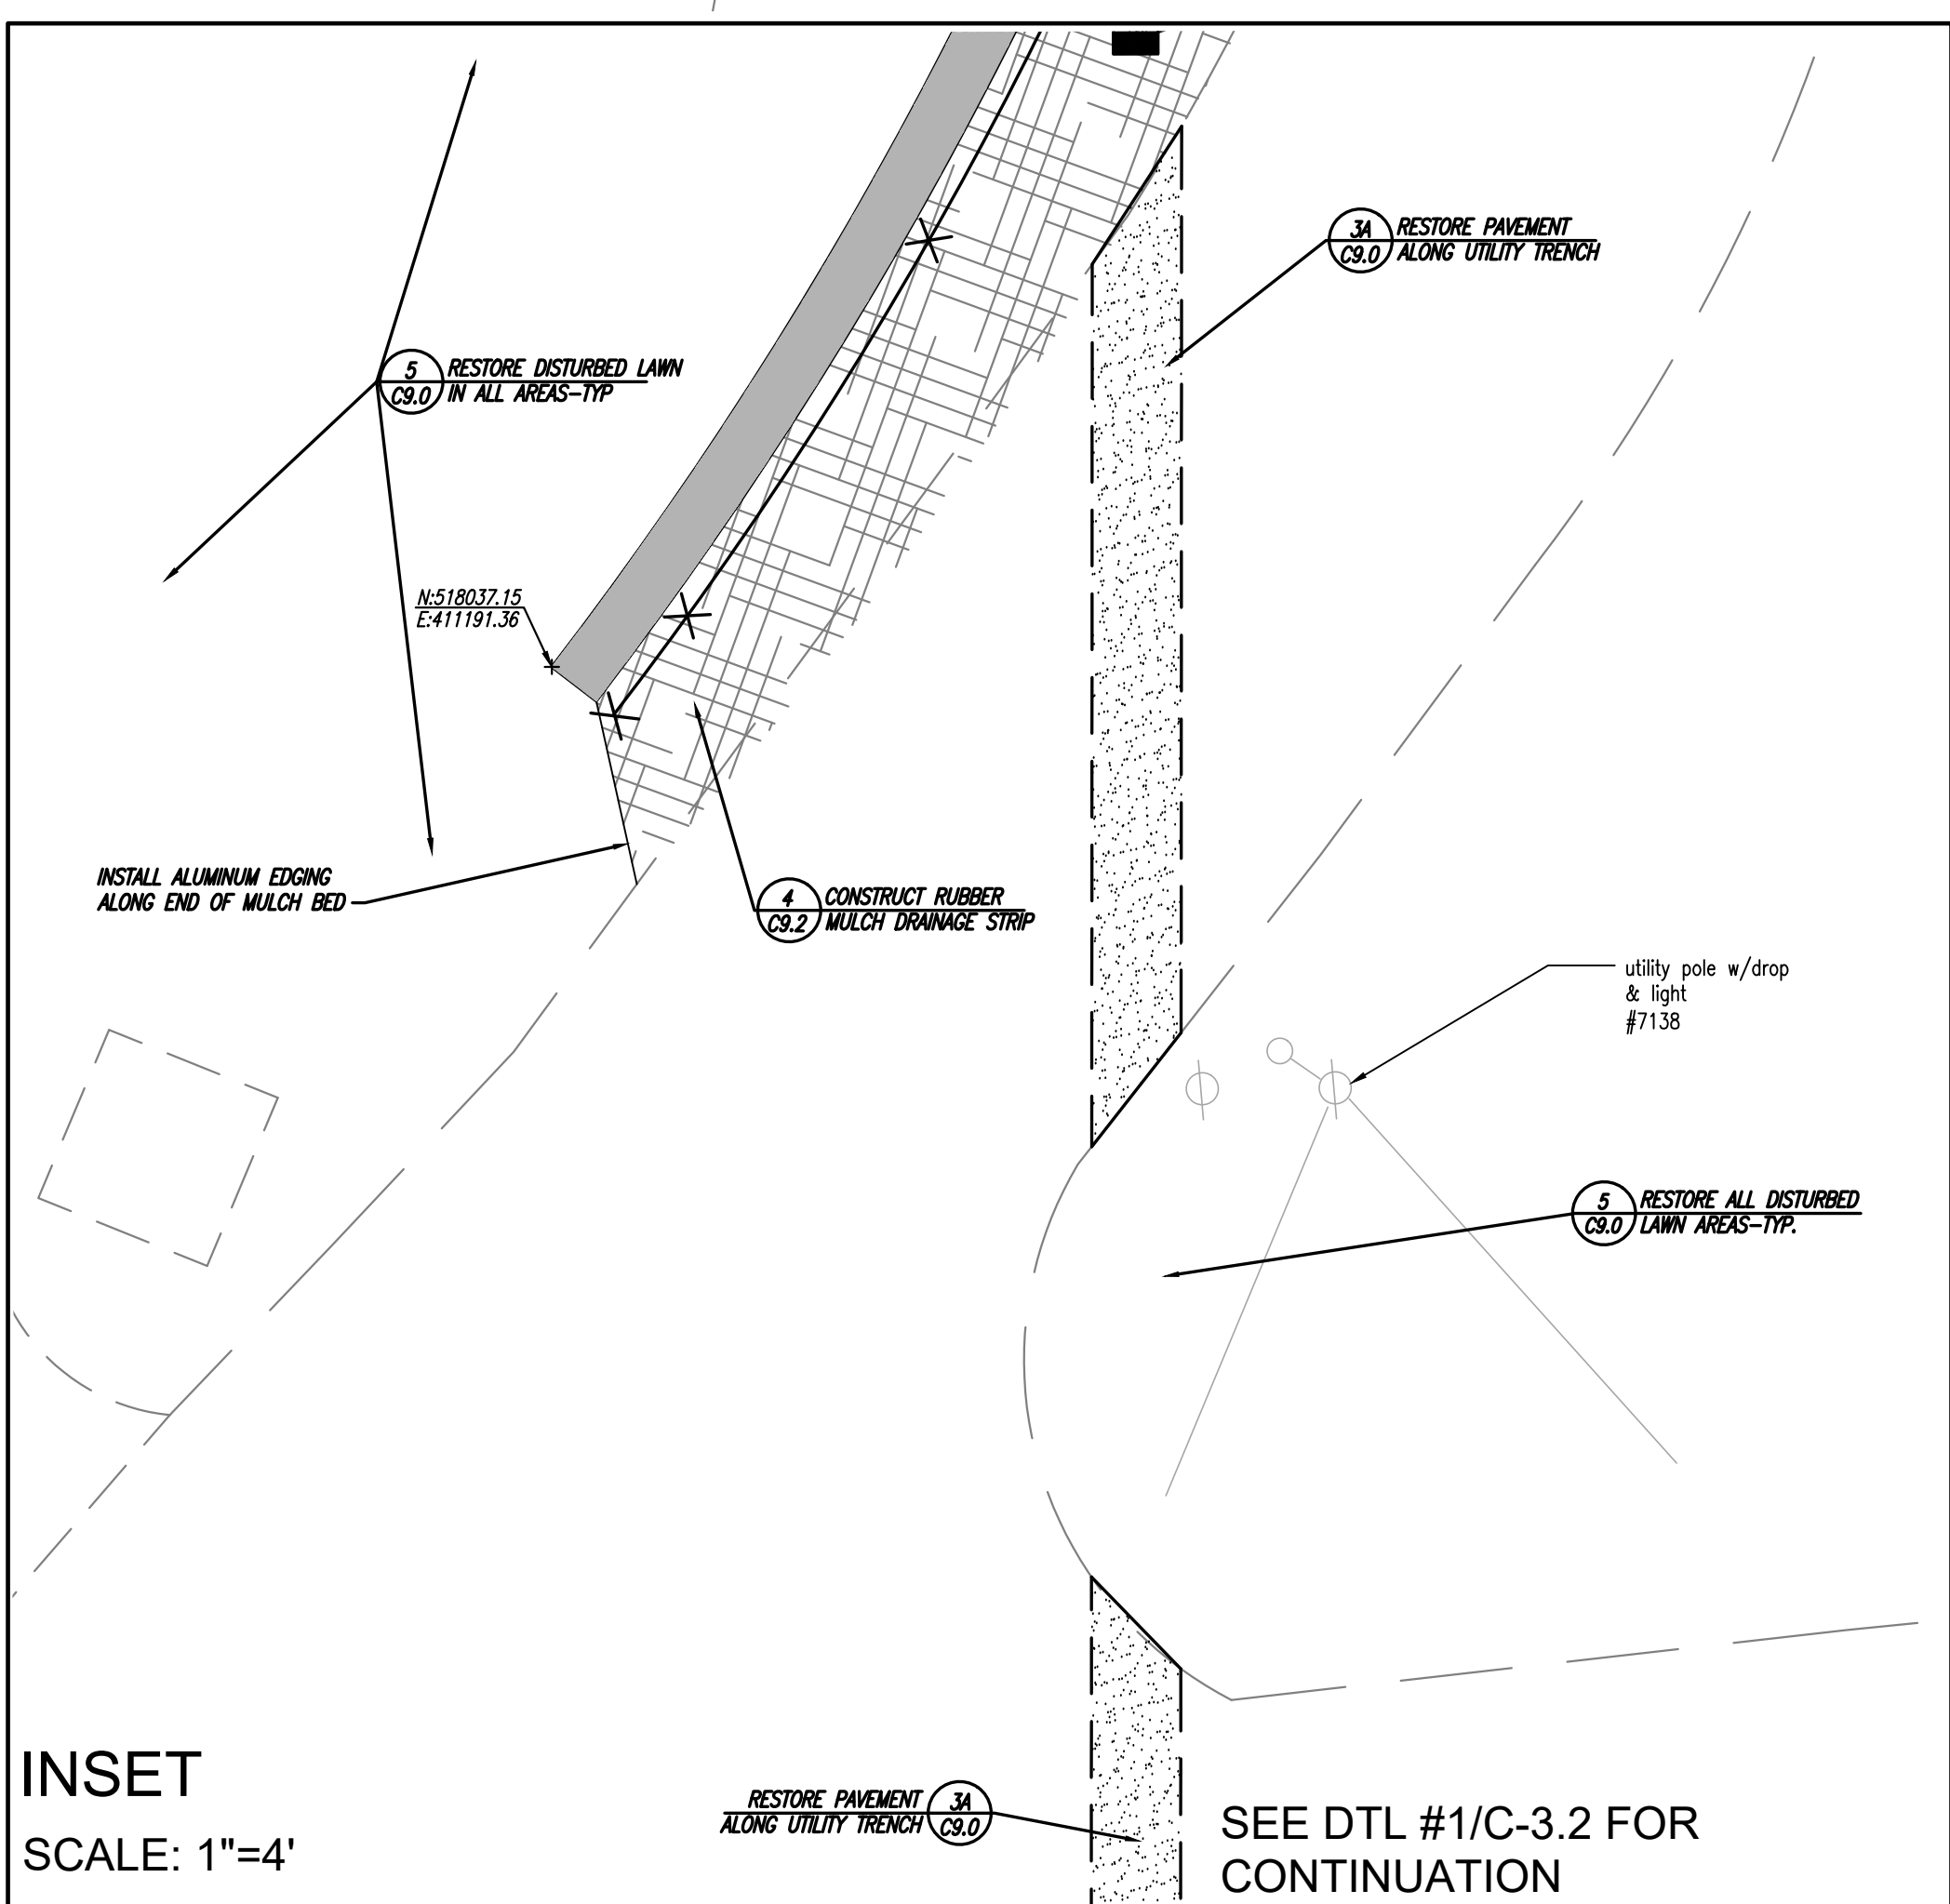

1 - SITE PLAN COMMEMORATIVE PLAZA AREA

SCALE: 1" = 4'

DATE: 06/16/22

JOHN J. VEIZ, AIA, CSBA
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WILLIAM D. HOPKINS III, AIA, LEED AP
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Fraytak Veisz Hopkins Duthie P C

Corporate: 1515 Lower Ferry Road - Trenton - New Jersey 08628
Pennsylvania: 140 Whittaker Ave. - Mont Clare - Pennsylvania 19453

F V H D P C . C O M

Project Name
Commemorative Plaza at Ewing High School

Project Owner Name
Ewing Public Schools

Project Location
900 Parkway Avenue, Ewing, NJ 08618

Project Number
5410

Project Date
06/16/2022

Checked By
WBE (EEG)

Drawn By
SRP (EEG)

Scale
AS NOTED

Drawing Name
ENLARGED SITE PLAN PLAZA AREA

Revisions

No.	Date	Description


Drawing Number
C3.1

Civil Engineering Consultant: EEG 1543A

EDWARDS
Engineering Group, Inc.


Certificate of Authorization: 24GA28008000
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William B. Edwards 06-17-22
WILLIAM B. EDWARDS, P.E. NJ Lic. No. GE36148

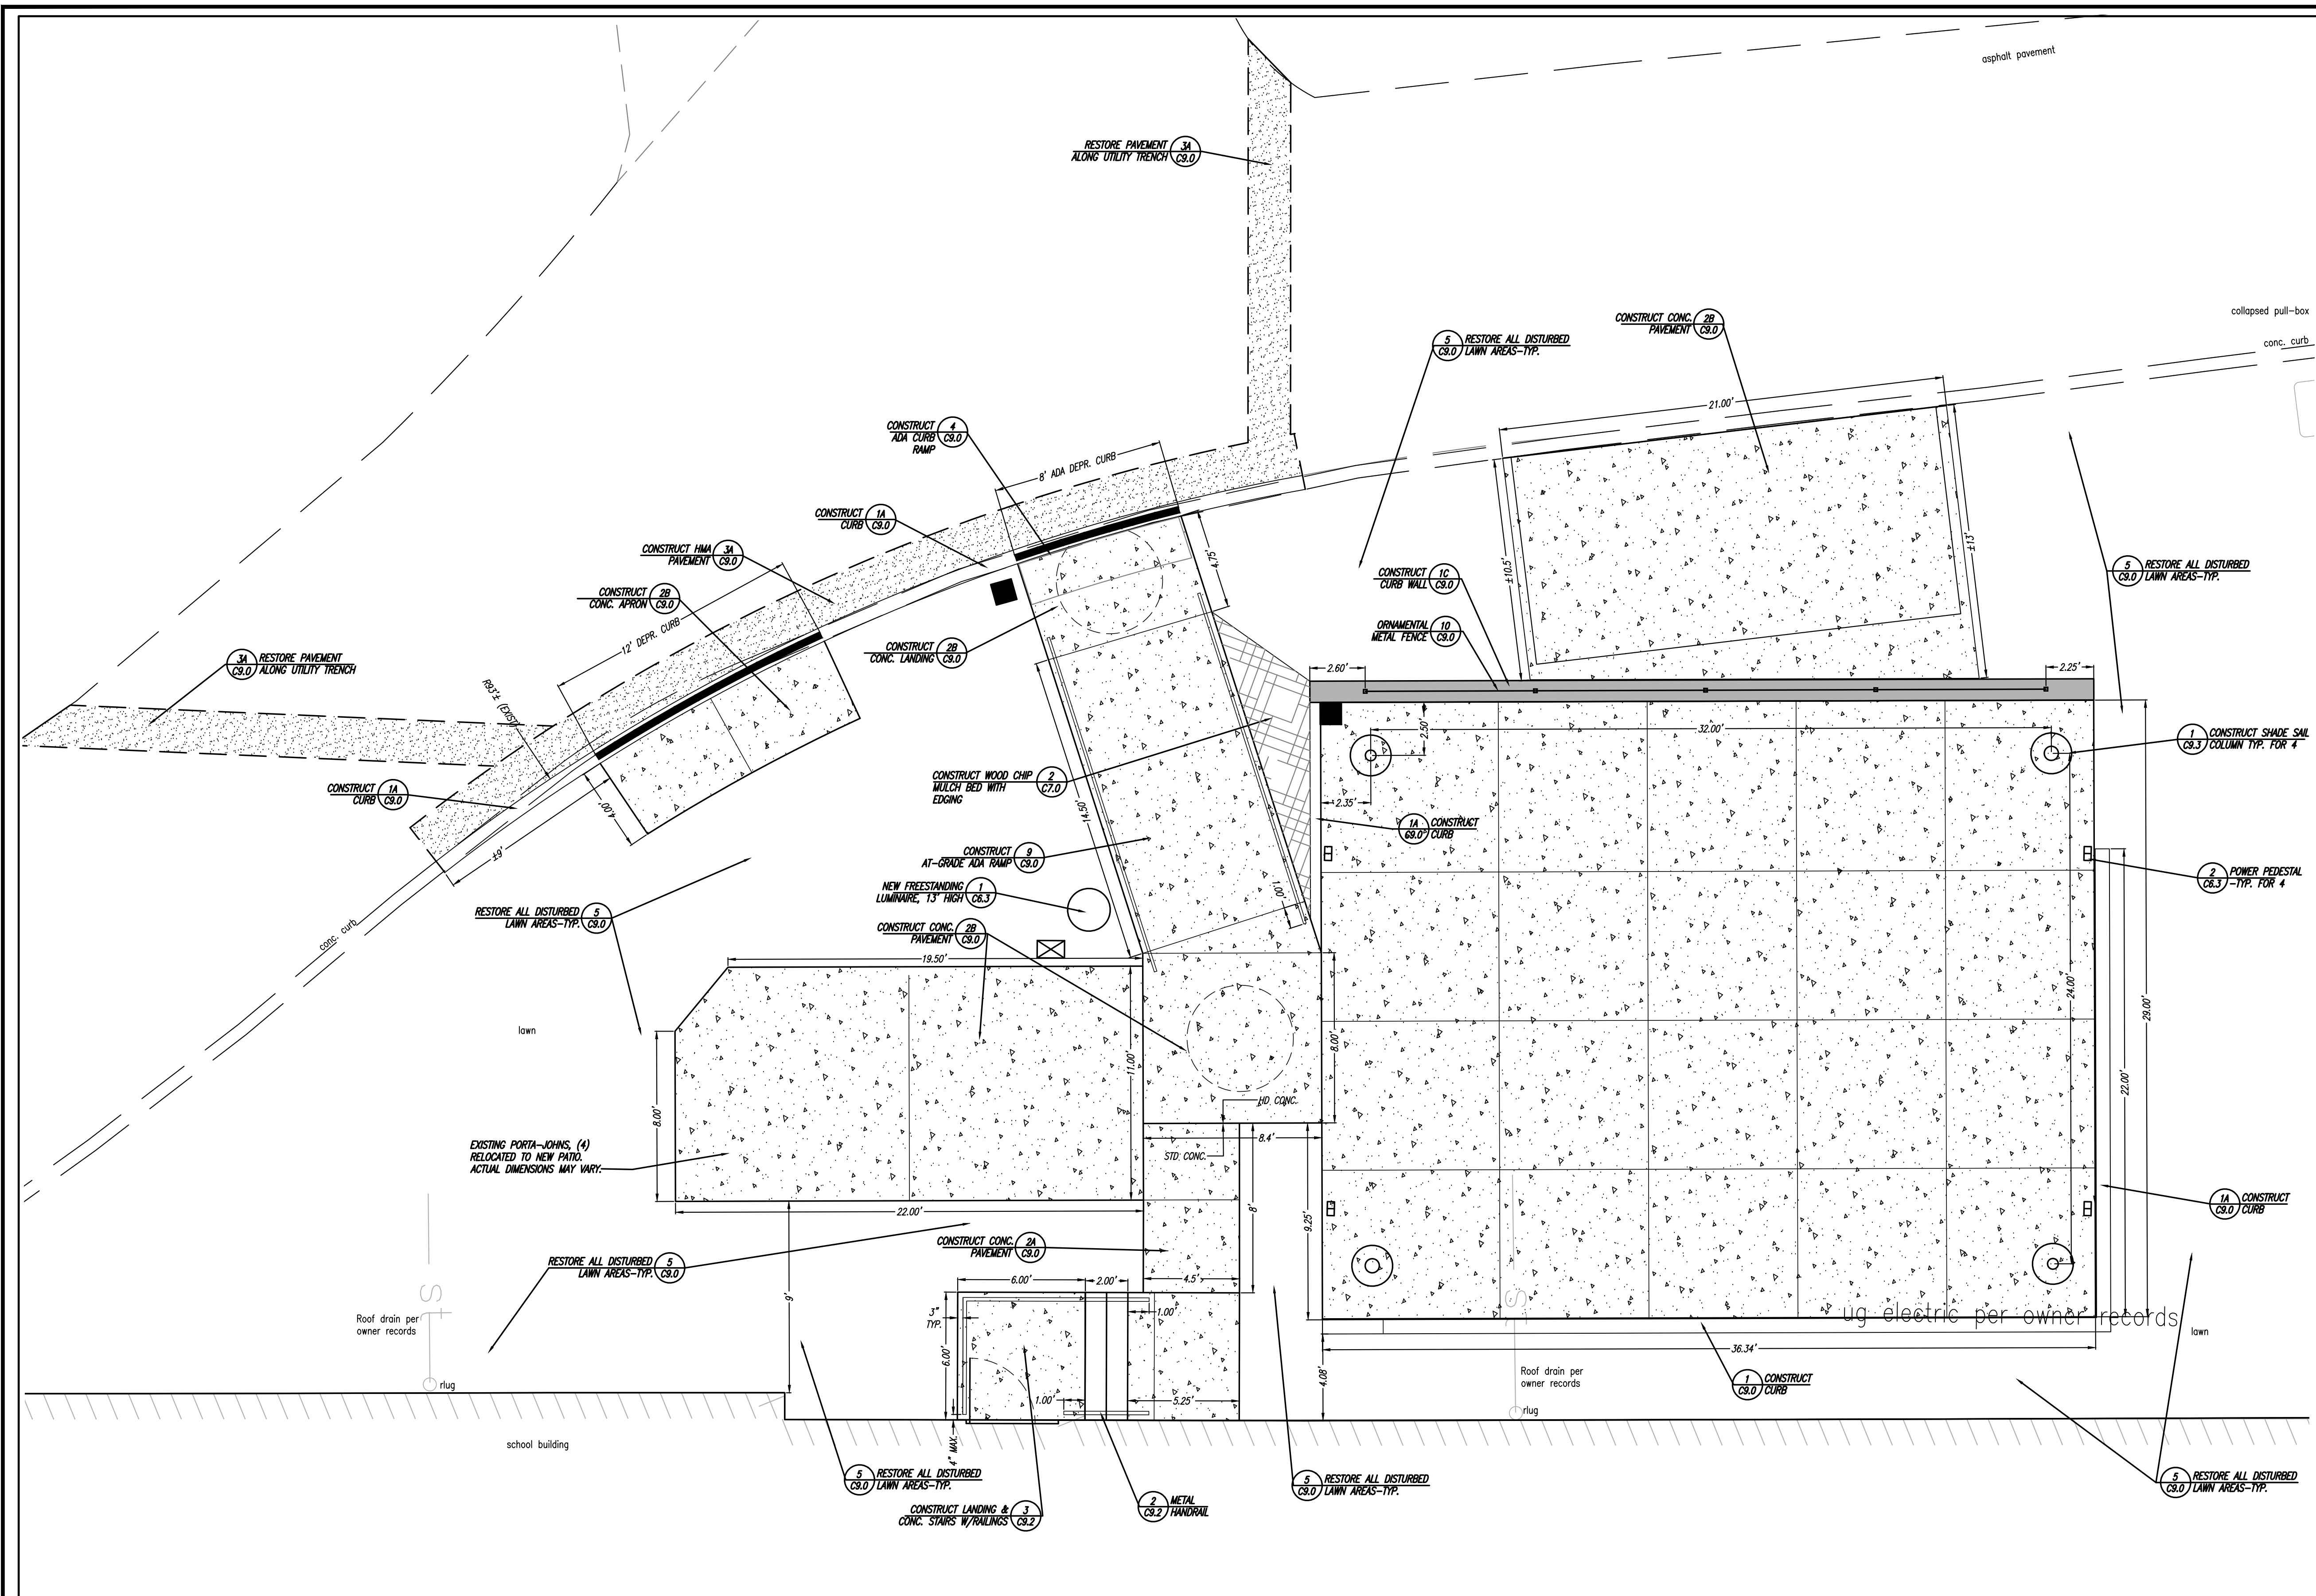

1- ENLARGED SITE PLAN - PAVILION AREA

SCALE: 1" = 4'

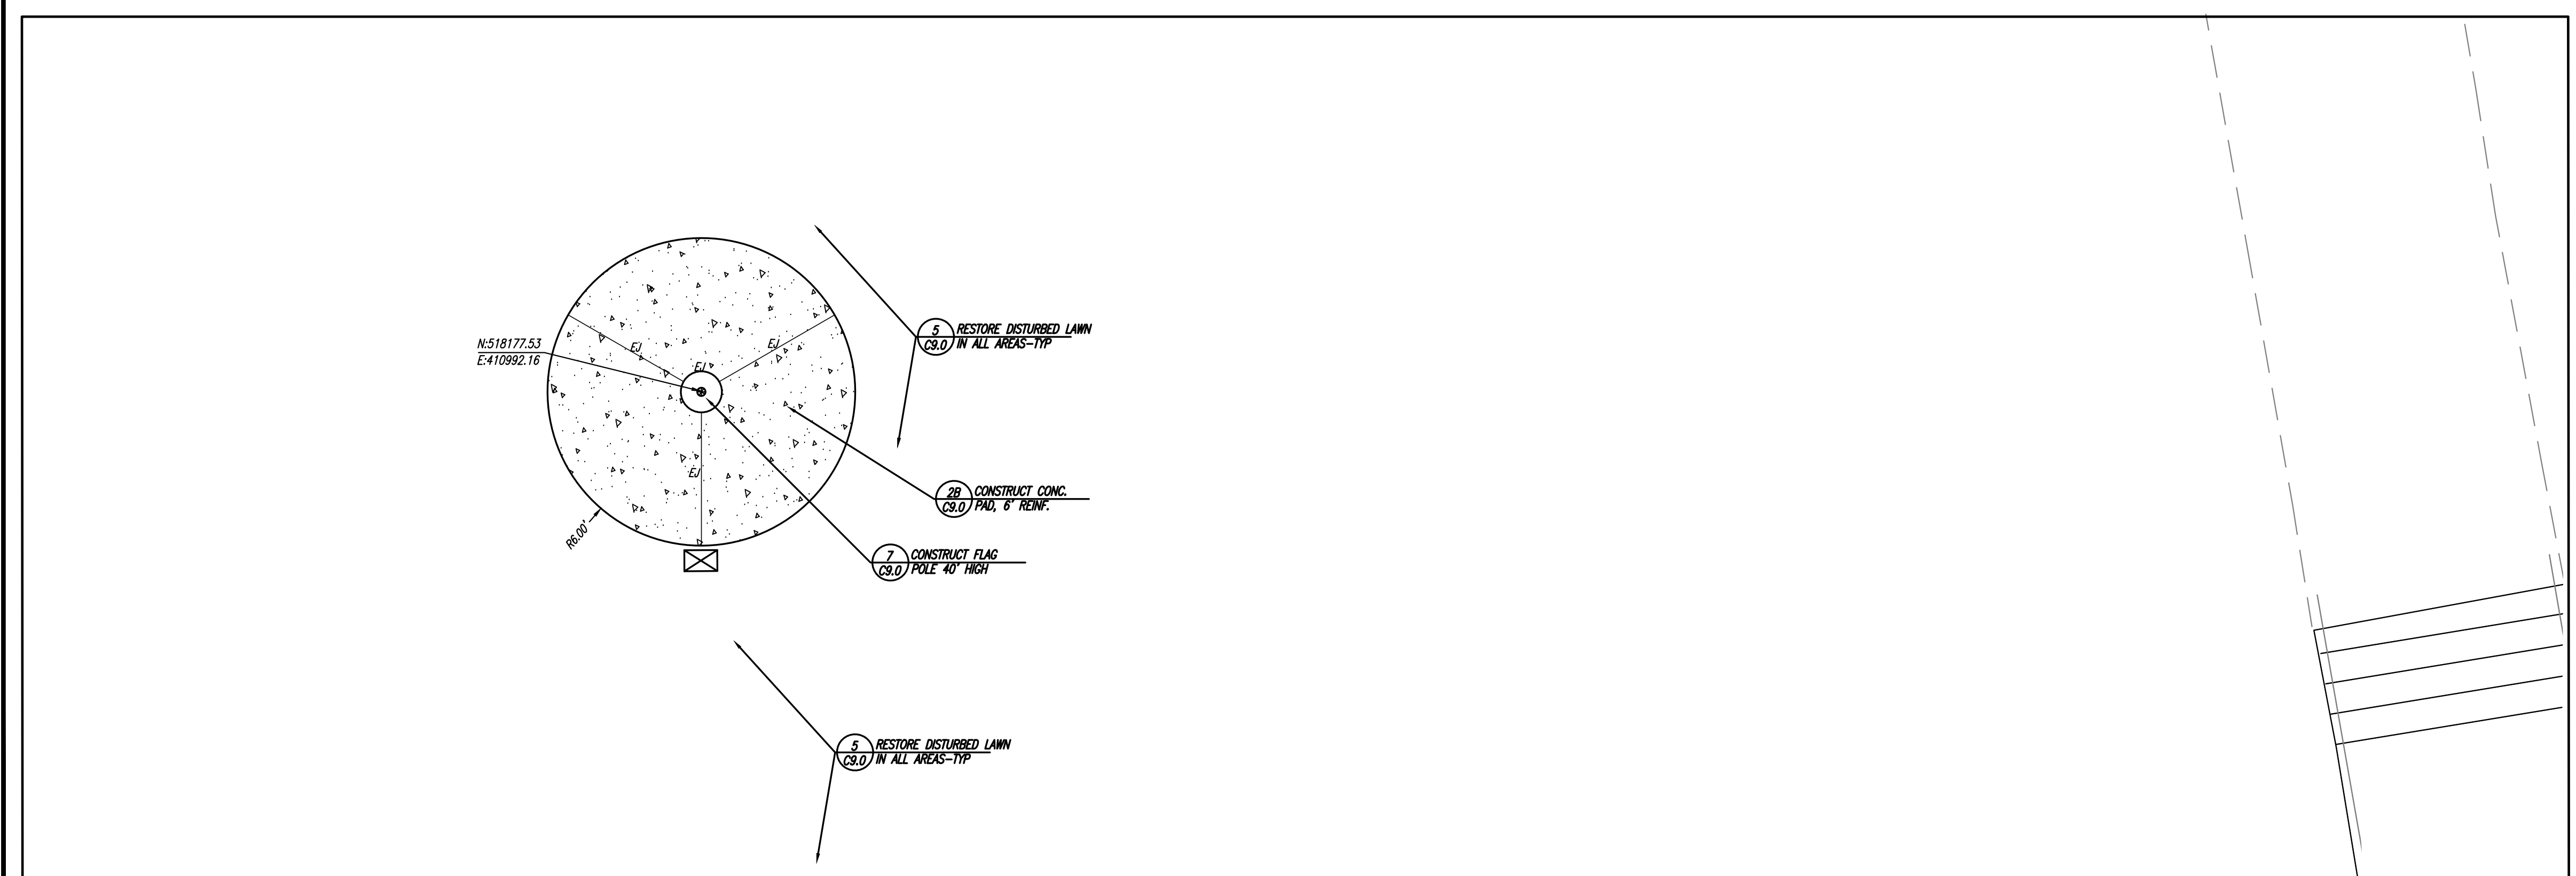

2- ENLARGED SITE PLAN - FLAG POLE AREA

SCALE: 1" = 4'


SEE DRAWING C-3.0 FOR NOTES THAT APPLY TO THIS WORK

LEGEND OF SYMBOLS & ABBREVIATIONS

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lowercase text	UPPERCASE TEXT	TEXT & NOTES	---	---	PAVEMENT EDGE
○	●	MANHOLE- NEW/RECONSTRUCT	□	▣	STANDARD DUTY PAVEMENT
□	▣	INLET- NEW/RECONSTRUCT	▨	▩	HEAVY DUTY PAVEMENT
○	○	CLEANOUT	---	---	CURB/DEPRESSED CURB
○	○	ROOF LEADER	---	---	PORTLAND CEMENT CONCRETE 6" THK, PER DETAIL 3/C-6
○	○	VALVE-TYPE	---	---	TREE/WOOD LINE
○	○	FIRE HYDRANT/FDC	---	---	BUSH/SHRUBS
○	○	UTIL. POLE/W-LIGHT/W-TRANSF.	---	---	EVERGREEN/DECIDUOUS TREES
○	○	STREET/TRAFFIC SIGNS	---	---	CONTOUR LINE
---	---	LIGHTS	---	---	SPOT ELEVATIONS
---	---	FENCE	---	---	
---	---	TEMP. CONSTRUCTION FENCE 6\"/>			

ABBREVIATIONS

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BW	BOTTOM WALL (GRADE)	HYD	FIRE HYDRANT	SS/SAN	SANITARY SEWER PIPE
C	CONDUIT	INV	INVERT (ELEV.)	TEL	TELEPHONE
COMM	DATA/COMMUNICATION CABLE	IT	INSIDE TRACK EDGE	TB	TOP OF BORDER
CONFIG	CONFIGURATION	LF	LINEAR FEET	TBR	TO BE REMOVED
CLF	CHAIN LINK FENCE	LP	LOW POINT	TC	TOP OF CURB
C.O.	CLEAN OUT	TP	TEST PIT	TF	TRANSFORMER
CONC	CONCRETE	TM	TOP OF WALL	TYP	TYPICAL
DC	DEPRESSED CURB	NIC	NOT IN CONTRACT	U/G	UNDERGROUND
DEMO	DEMOLITION	OT	OVERHEAD	U/GP	UTILITY POLE
DIP	DUCTILE IRON PIPE	PC	POINT OF CURVE	V.I.F.	VERIFY IN FIELD
DSP	DOWN SPOUT	PCC	POINT OF COMPOUND CURVE	W	WATER
E	ELECTRIC	PEP	POLYETHYLENE PIPE (HOPE)	WV	WATER VALVE
ELEV	ELEVATION (FT.)	PROP	PROPOSED		
EX	EXISTING	PT	POINT OF TANGENT		
FDC	FIRE DEPT. CONN.	PVC	POLYVINYL CHLORIDE PIPE		
FM	FORCE MAIN (SEWAGE)				
FO	FOOTING				
FTG.	FOOTING				

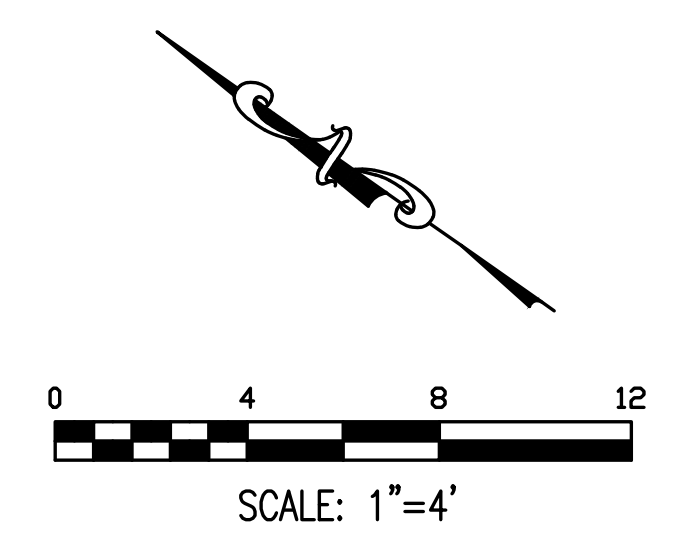

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George E. Duthie Jr.
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Date

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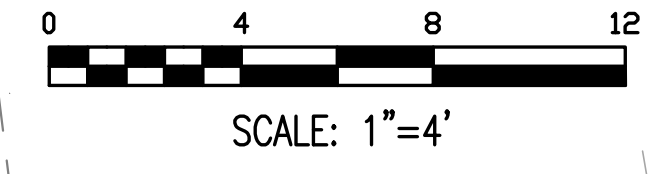
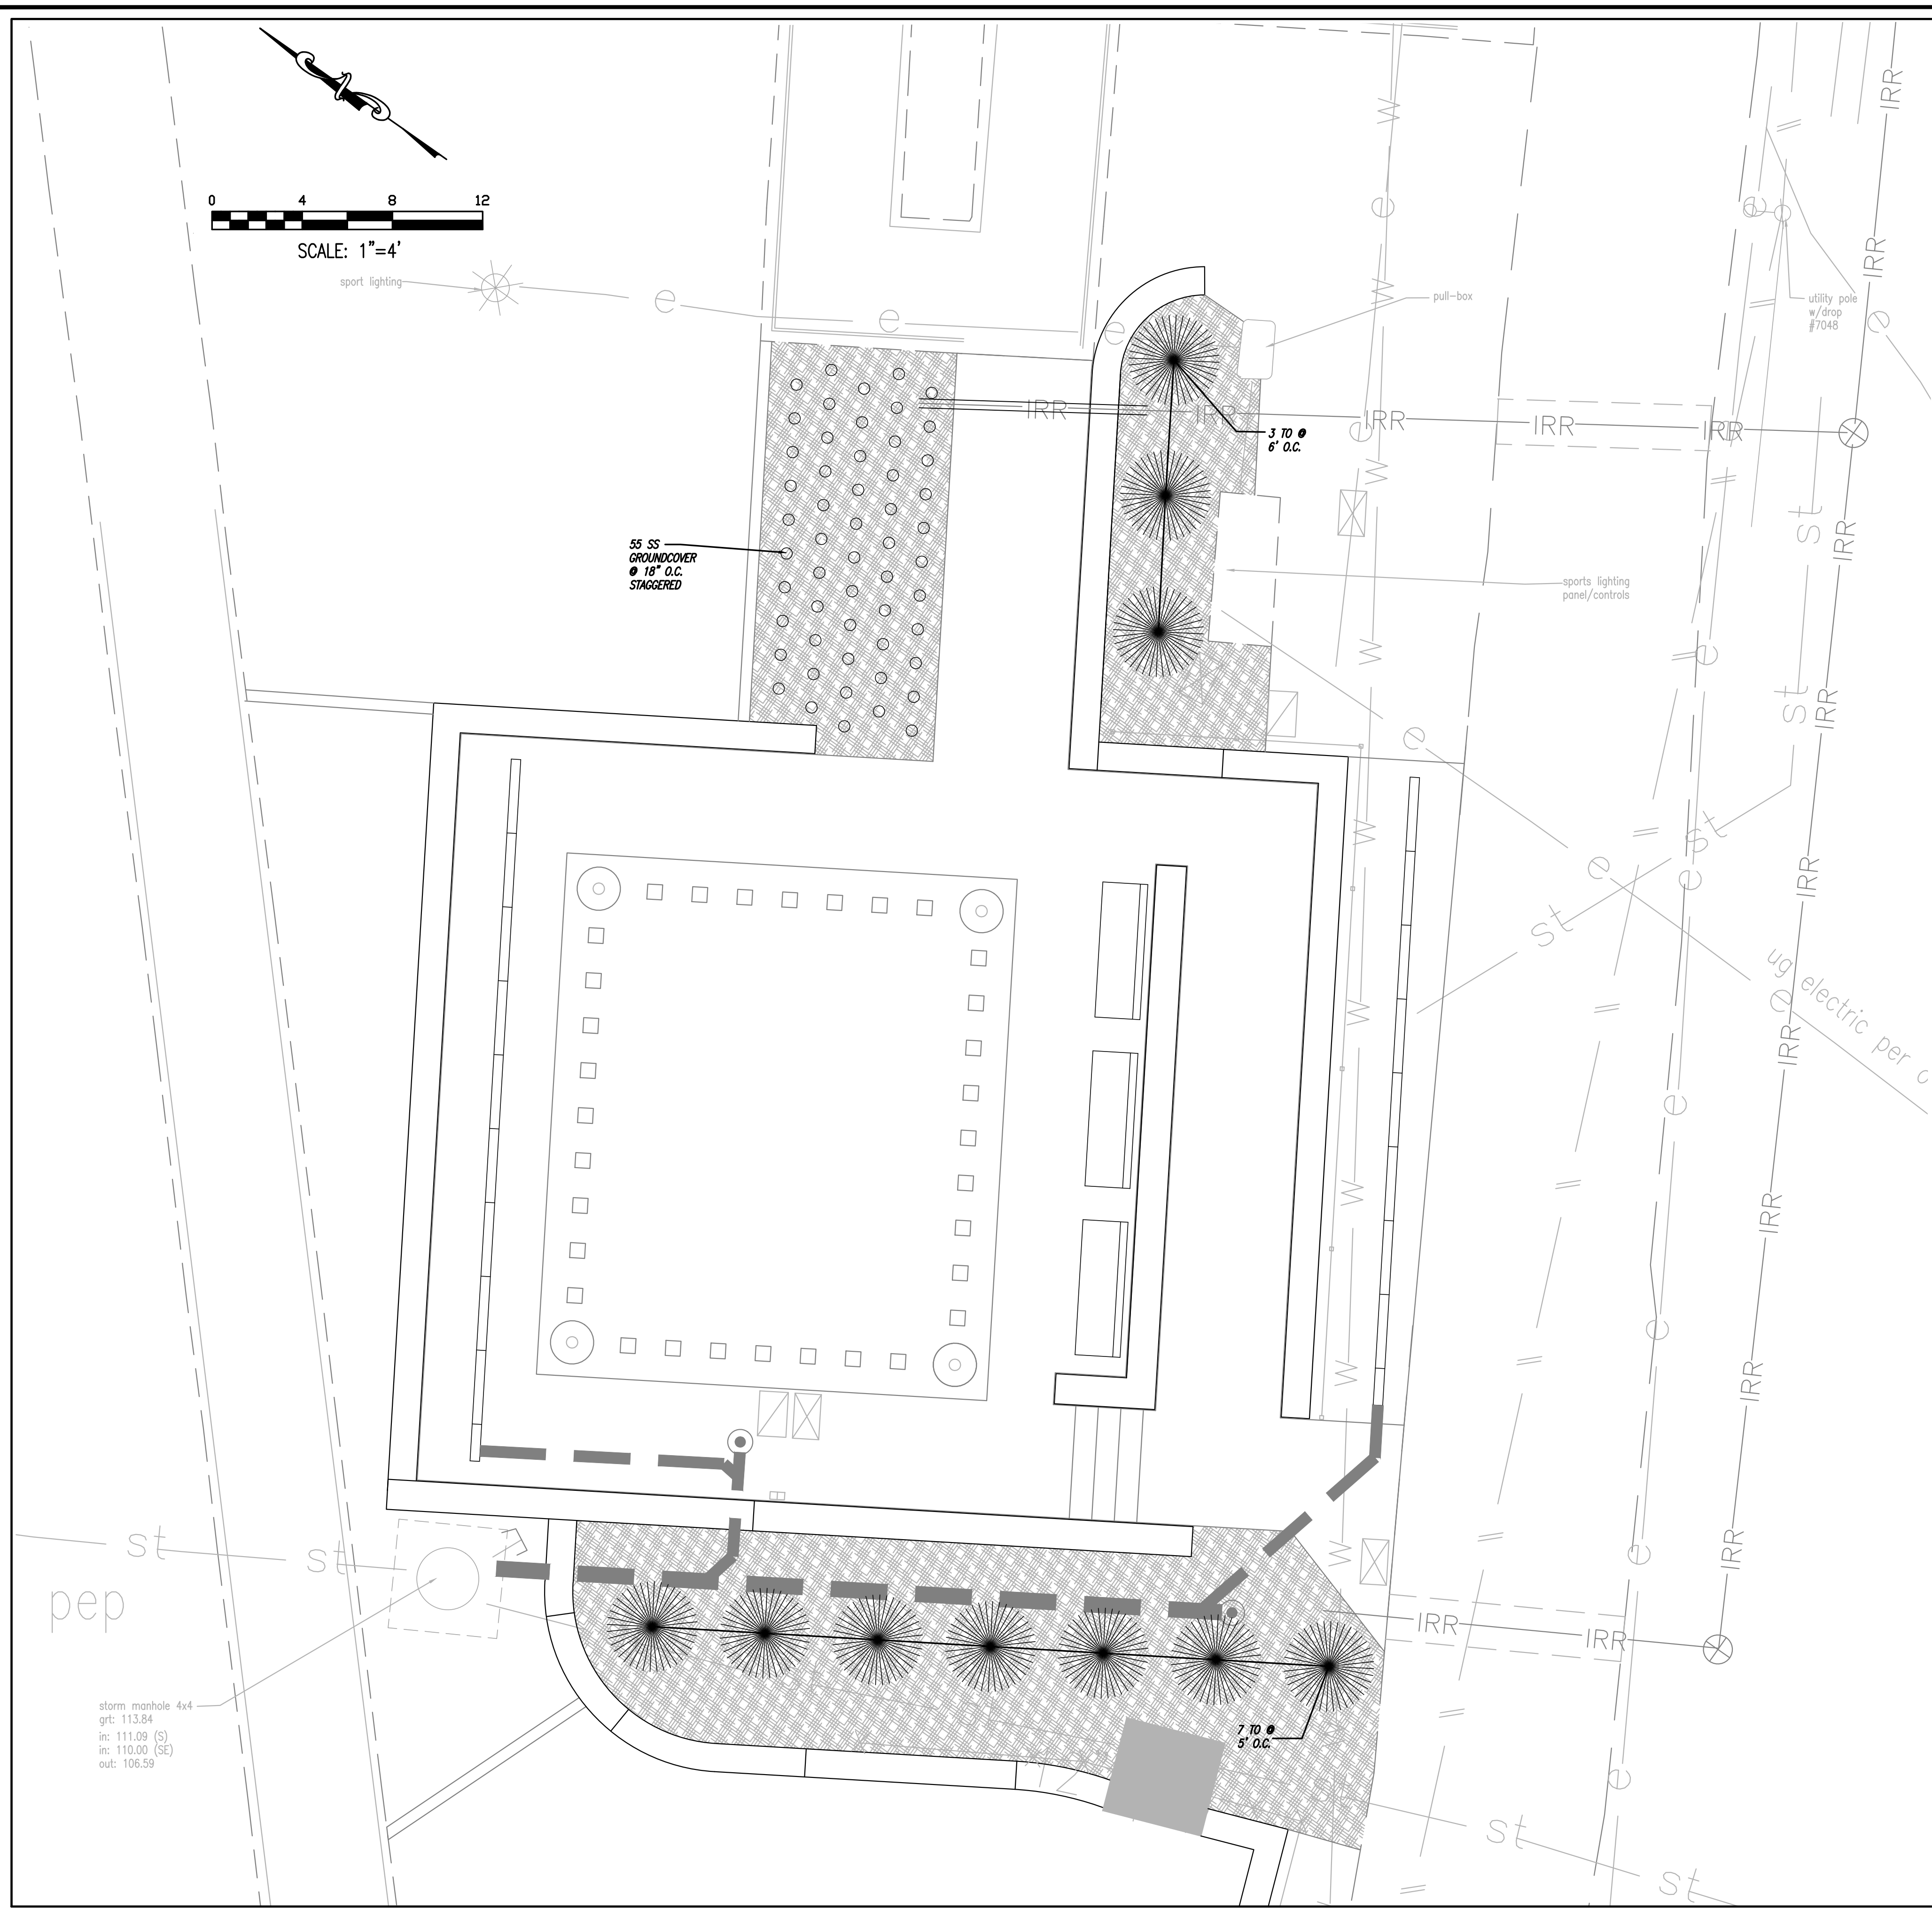
Scale
AS NOTED

Drawing Name
ENLARGED SITE PLAN PAVILION & FLAG POLE AREAS

Revisions

No.	Date	Description

Drawing Number
C3.2



1 - LANDSCAPING PLAN - PLAZA AREA

SCALE: 1" = 4'

PLANTING SCHEDULE

QTY.	SYM.	BOTANICAL NAME	COMMON NAME	INSTALLED SIZE	MATURE HGT.	SPACING
10	TO	THUJA OCCIDENTALIS	EMERALD GREEN ARBORVITAE	5'-6" HIGH	16"	5'-6" O.C.
55	SS	SEDUM HYBRID	SUPERSTAR SEDUM (GROUNDCOVER)	#1 BULB	10"-12"	18" O.C.

O.C. ON CENTER
* EXERCISE CARE WHEN PLANTING NEAR UNDERGROUND UTILITIES.

- PLANTING NOTES:**
- ALL PLANT MATERIALS USED SHALL BE TRUE TO NAME AND SIZE IN CONFORMITY WITH THE CURRENT EDITION OF THE AMERICAN STANDARD OF NURSERY STOCK AND SHALL BE TYPICAL OF THEIR SPECIES OR VARIETY. ALL PLANTS SHALL HAVE NORMAL, WELL-DEVELOPED BRANCHES AND VIGOROUS ROOT SYSTEMS. THEY SHALL BE SOUND, HEALTHY, VIGOROUS, FREE FROM DEFECTS, DISFIGURING KNOTS, ABRASIONS OF THE BARK, SUN SCALD INJURIES, PLANT DISEASES, INSECT EGGS, BORERS, AND ALL OTHER FORMS OF INFECTION. ALL PLANTS SHALL BE NURSERY GROWN.
 - ALL PLANT MATERIAL SHALL BEAR THE SAME RELATION TO FINISHED GRADE AS IT BORE TO EXISTING GRADE AT THE NURSERY.
 - ALL PLANT MATERIAL IS TO BE GUARANTEED FOR THE ENTIRE MAINTENANCE PERIOD OF THE CONTRACT, BUT NOT LESS THAN A PERIOD TWELVE MONTHS FROM TIME OF FINAL ACCEPTANCE OF THE PROJECT BY THE OWNER. IF ANY PLANTS ARE DEAD OR IN AN UNHEALTHY CONDITION BEFORE FINAL ACCEPTANCE OF THE PROJECT, THE LANDSCAPE CONTRACTOR SHALL REPLACE THEM AT HIS EXPENSE.
 - ANY SUBSTITUTIONS OF PLANT MATERIAL WITH REGARDS TO SIZE, SPECIES, VARIETY, ETC., SHALL BE SUBJECT TO APPROVAL BY THE PROJECT ENGINEER AND THE OWNER.
 - PRUNE TWO EXISTING TREES TO REMOVE DEAD LIMBS. LOP LOWER BRANCHES TO PROVIDE MINIMUM 5 FOOT CLEARANCE ABOVE GRADE ON ALL SIDES OF THE TREES. TRIM LIMBS TO PROVIDE A MINIMUM OF 2 FEET OF CLEARANCE FROM THE FOOTPRINT OF THE NEW PERGOLA (TRELLIS) AS SHOWN ON THE PLAN. TRIM LIMBS AND BRANCHES TO A HEIGHT OF 12 FEET ABOVE GRADE. LIMBS SHALL BE CLEANLY CUT BY A QUALIFIED ARBORIST. UNDER NO CIRCUMSTANCES SHOULD THE MAIN LEADER OF A TREE BE TOPPED.
 - CUT AND REMOVE BURLAP FROM TOP ONE-THIRD OF BALL. ALL PLASTIC MATERIAL, SYNTHETIC BURLAP AND STRING OR CONTAINERS SHALL BE REMOVED AT THE TIME OF PLANTING. THE WIRE BASKETS AND PLASTIC LINERS OF GROWN TREES AND SHRUBS MUST BE COMPLETELY REMOVED. NO CONTAINER GROWN MATERIAL WILL BE ACCEPTED IF IT IS ROOT BOUND.
 - THE DEPTH OF PLANT PITS SHALL BE INCREASED BY 12" THROUGH THE ADDITION OF LOOSE AGGREGATE (3/4" TO 1 1/2" DIAMETER) WHEREVER POOR DRAINAGE OCCURS OR WHERE DIRECTED BY THE PROJECT ENGINEER.
 - PLANTING BACKFILL MIXTURE SHALL CONSIST OF ONE PART TOPSOIL, ONE PART NATIVE SOIL, AND ONE PART PEAT MOSS. NOTE THAT PLANTING MIXTURE MAY CHANGE BASED UPON SOIL CONDITIONS.
 - CONSTRUCT ORGANIC MULCH PER PROJECT SPECIFICATIONS, WITHIN THE HATCHED AREA SHOWN. MULCH SHALL BE EITHER WOOD CHIPS OR SHREDDED HARDWOOD BARK NOT EXCEEDING 2" IN GREATEST DIMENSION. ALL MULCHED BEDS SHALL BE RETAINED BY AN ALUMINUM BORDER, THE CONTRACTOR SHALL FILL EACH PLANTING PIT WITH WATER AND ALLOW IT TO FULLY PERCOLATE INTO THE GROUND PRIOR TO PLACEMENT OF THE PLANT. THE CONTRACTOR SHALL NOTIFY THE ENGINEER OF ANY PERCOLATION PROBLEMS PRIOR TO INSTALLATION.
 - NO PLANTING SHALL BE EXECUTED DURING PERIODS OF HOT WEATHER NOR WHEN THE GROUND IS FROZEN.
 - THE CONTRACTOR SHALL REMOVE ALL DAMAGED BRANCHES AND NURSERY TAGS AT THE TIME OF INSTALLATION.
 - (3) SLOW RELEASE FERTILIZER TABLETS OR PACKETS OF 20-10-5 COMPOSITION SHALL BE ADDED TO ALL PLANTING PITS FOR TREES.
 - THE CONTRACTOR SHALL ENGAGE AN UNDERGROUND UTILITY LOCATING SERVICE TO MARK ALL UTILITIES IN CLOSE PROXIMITY TO PLANTED AREAS. IN ADDITION THE CONTRACTOR MUST REVIEW ALL DRAWINGS TO DETERMINE THE APPROXIMATE LOCATION OF UNDERGROUND UTILITIES THAT HAVE BEEN IDENTIFIED AND PROTECT ALL UTILITIES.

LEGEND OF SYMBOLS & ABBREVIATIONS

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lowercase text	UPPERCASE TEXT	TEXT & NOTES	---	---	PAVEMENT EDGE
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□	■	INLET - NEW/RECONSTRUCT	---	---	HEAVY DUTY PAVEMENT
○ c.o.	○	CLEANOUT	---	---	CURB/DEPRESSED CURB
○ plug	○	ROOF LEADER	---	---	PORTLAND CEMENT CONCRETE 6" THK. PER DETAIL 3/C-4
gv	gv	VALVE-TYPE	---	---	TREE/WOOD LINE
○	○	FIRE HYDRANT/FDC	---	---	BUSH/SHRUBS
○	○	UTIL. POLE/W-LIGHT/W-TRANSF.	---	---	EVERGREEN/DECIDUOUS TREES
○	○	STREET/TRAFFIC SIGNS	---	---	CONTOUR LINE
○	○	LIGHTS	---	---	SPOT ELEVATIONS
○	○	FENCE	---	---	
○	○	TEMP. CONSTRUCTION FENCE 6" CHAIN LINK PER SPEC.	---	---	
○	○	FULL-DEPTH DEMOLITION	---	---	
○	○	HAND HOLE - ELEC/DATA	---	---	

ABBREVIATIONS

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BT	BOTTOM OF TRENCH	HC	HANDICAPPED HIGH POINT	SCD	SOIL CONSERVATION DISTRICT
BW	BOTTOM WALL (GRADE)	HP	HIGH POINT	ST	STORM SEWER PIPE
C	CONDUIT	HYD	FIRE HYDRANT	SS/SAN	SANITARY SEWER PIPE
COMM	DATA/COMMUNICATION CABLE	INV	INVERT (ELEV.)	TEL	TELEPHONE
CONF.	CONFIGURATION	IT	INSIDE TRACK EDGE	TB	TOP OF BORDER
CLF	CHAIN LINK FENCE	LF	LINEAR FEET	TBR	TO BE REMOVED
C.O.	CLEAN OUT	LP	LOW POINT	TC	TOP OF CURB
CONC	CONCRETE	MH	MANHOLE	TP	TEST PIT
DC	DEPRESSED CURB	N/C	NOT IN CONTRACT	TRANSF	TRANSFORMER
DEM	DEMOLITION	OV	OVERHEAD	TW	TOP OF WALL
DIP	DUCTILE IRON PIPE DOWN SPOUT	O/H	OUTSIDE TRACK EDGE	TYP	TYPICAL
DIS	ELECTRIC	PC	POINT OF CURVE	U/G	UNDERGROUND
E	ELEVATION (FT.)	PCC	POINT OF COMPOUND CURVE	U/P	UTILITY POLE
EV	EXISTING	PEP	POLYETHYLENE PIPE (HDPE)	V.I.F.	VERIFY IN FIELD
FDC	FIRE DEPT. CONN.	PROP	PROPOSED	W	WATER
FM	FORCE MAIN (SEWAGE)	PT	POINT OF TANGENT	WV	WATER VALVE
FO	FIBER OPTIC CABLE	PVC	POLYVINYL CHLORIDE PIPE		
FTG.	FOOTING				






Civil Engineering Consultant: EEG 1543A

EDWARDS
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Certificate of Authorization: 24GA28008000
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Date: 06-17-22



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6/16/22
Date

F V H D P C C O M

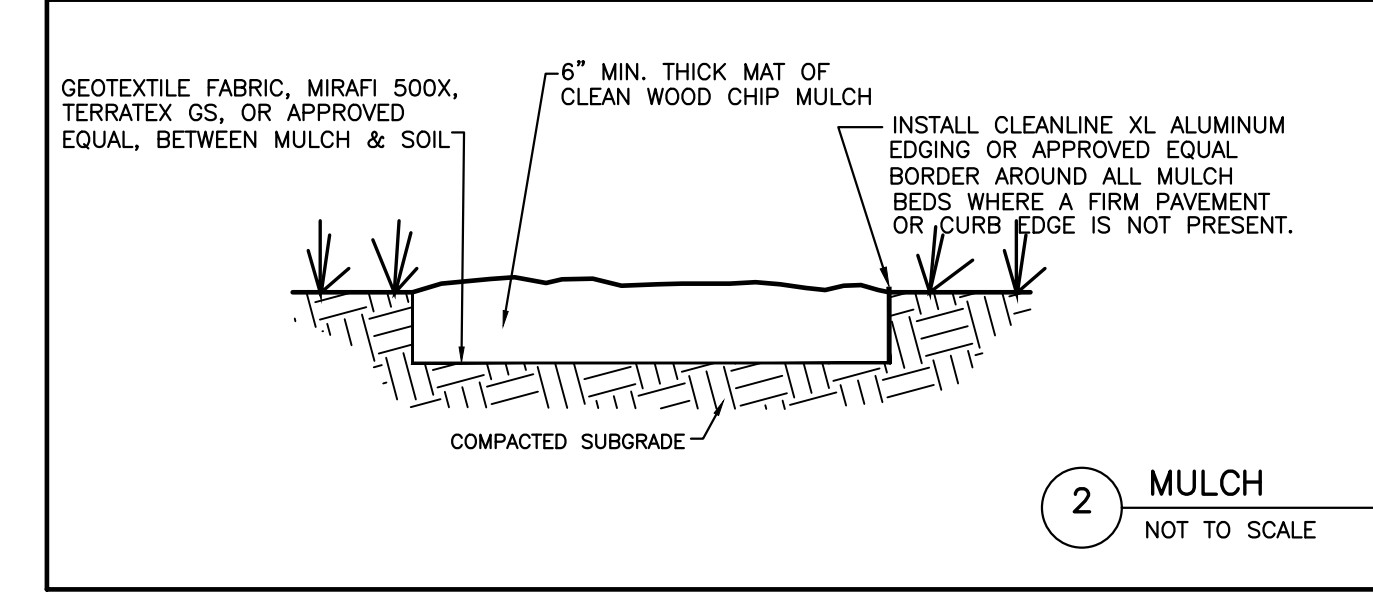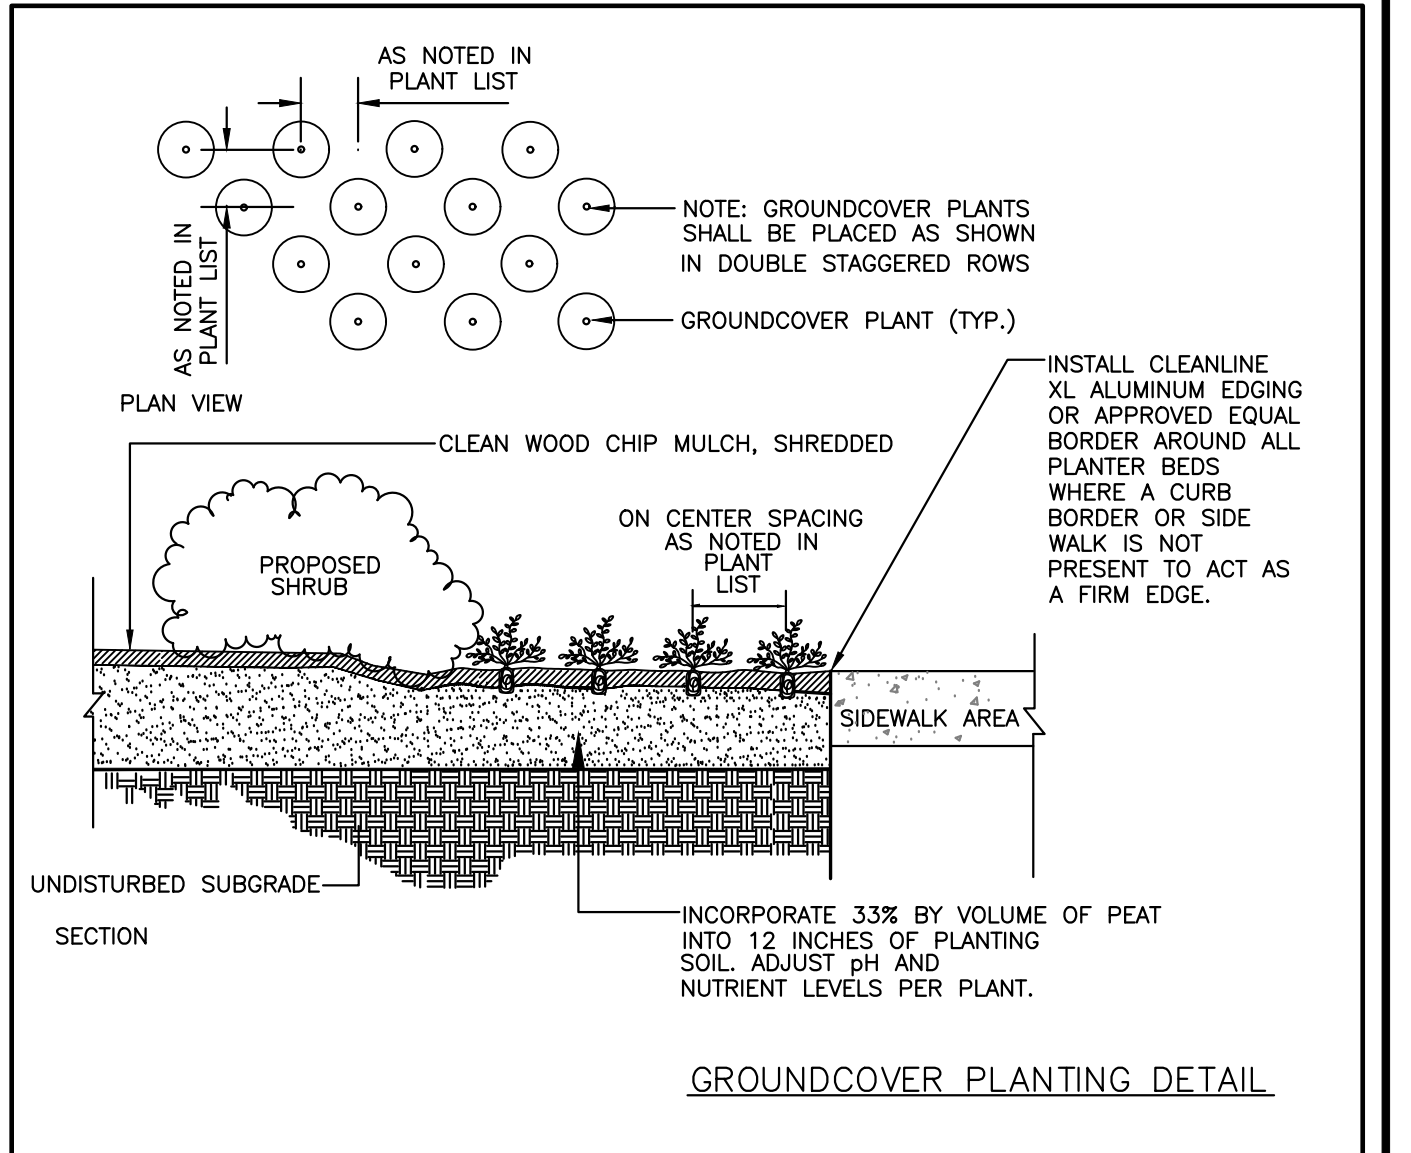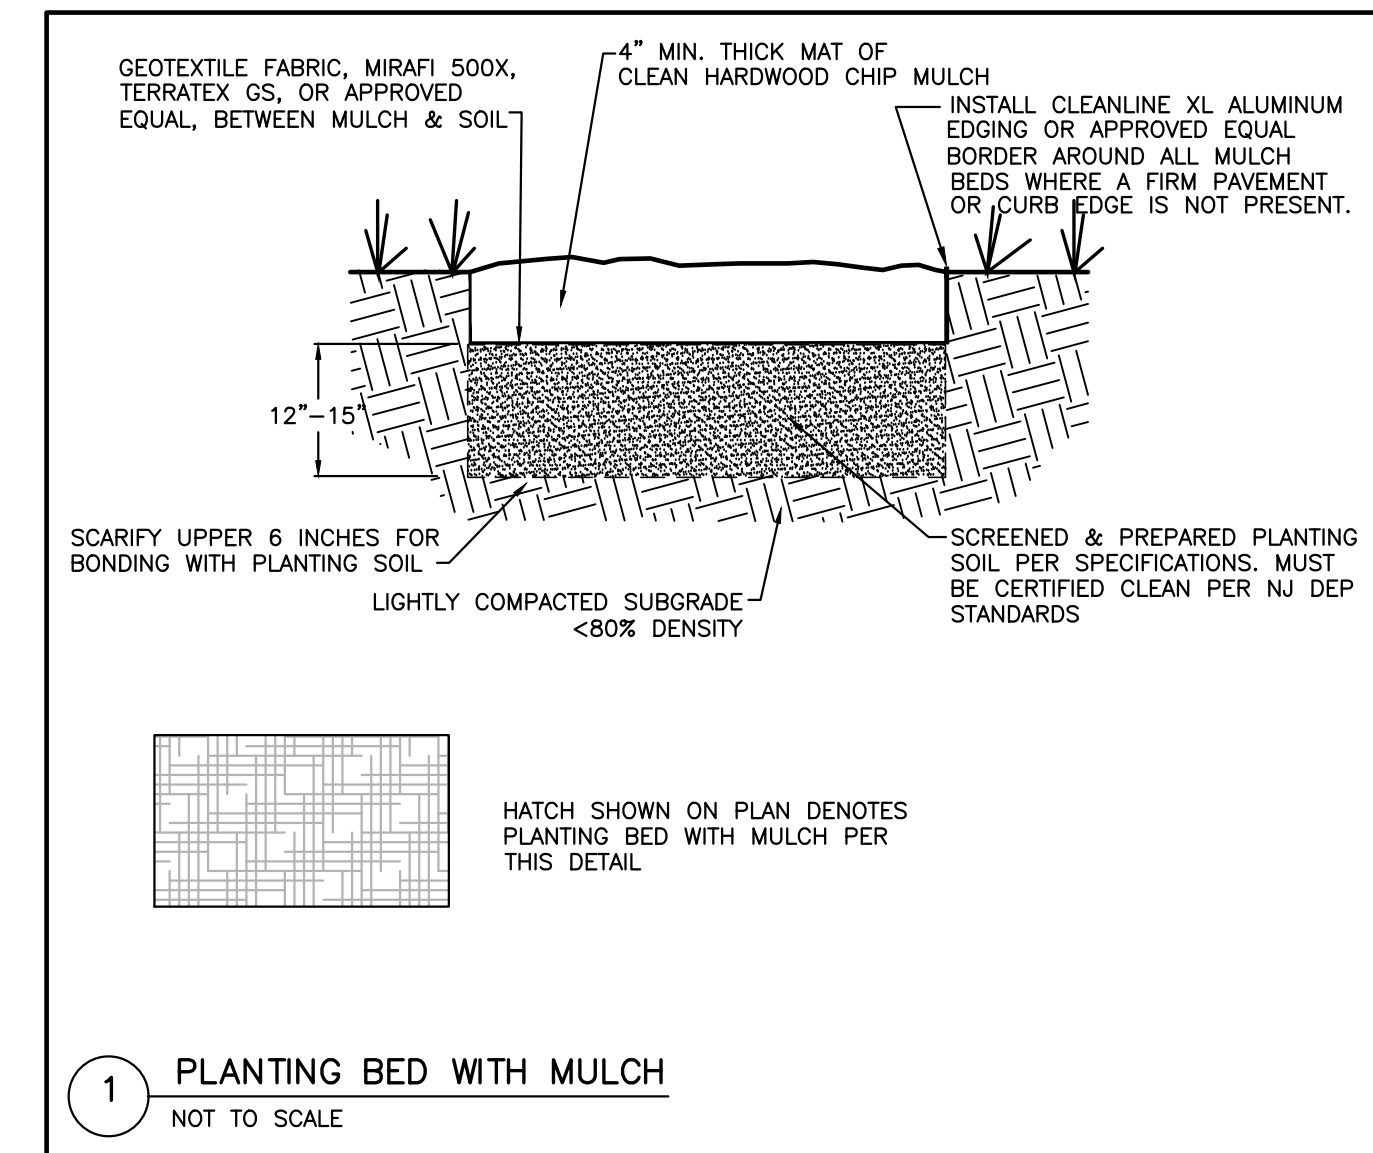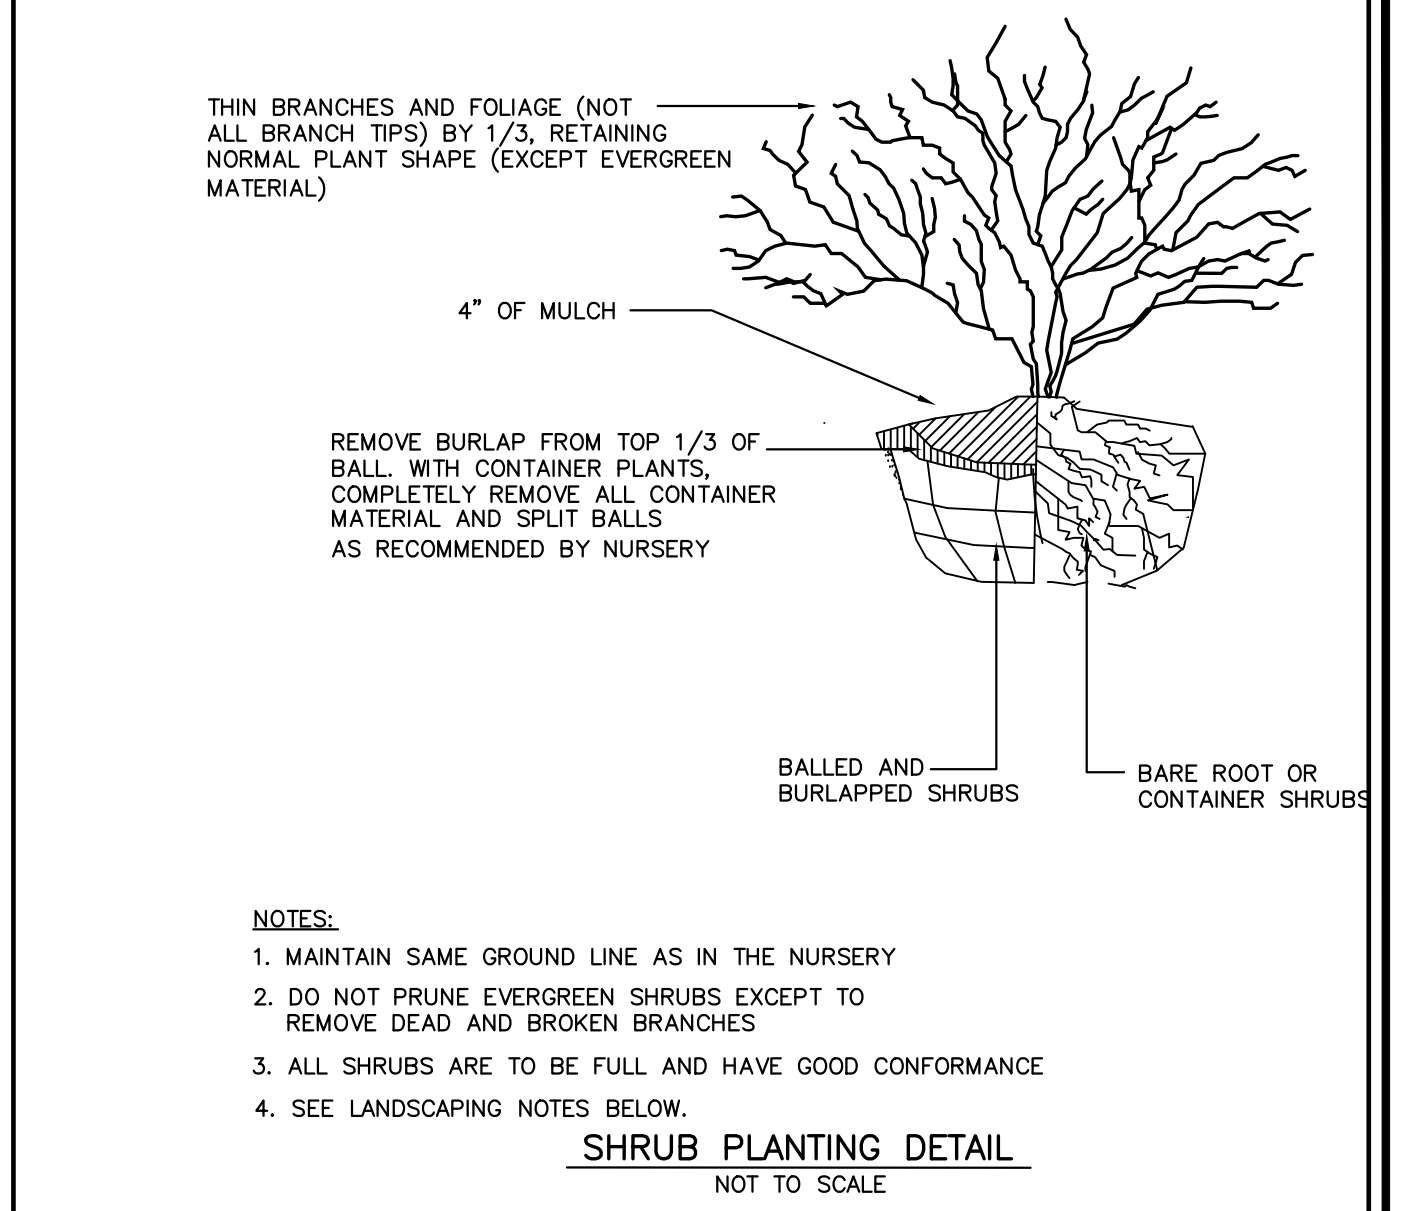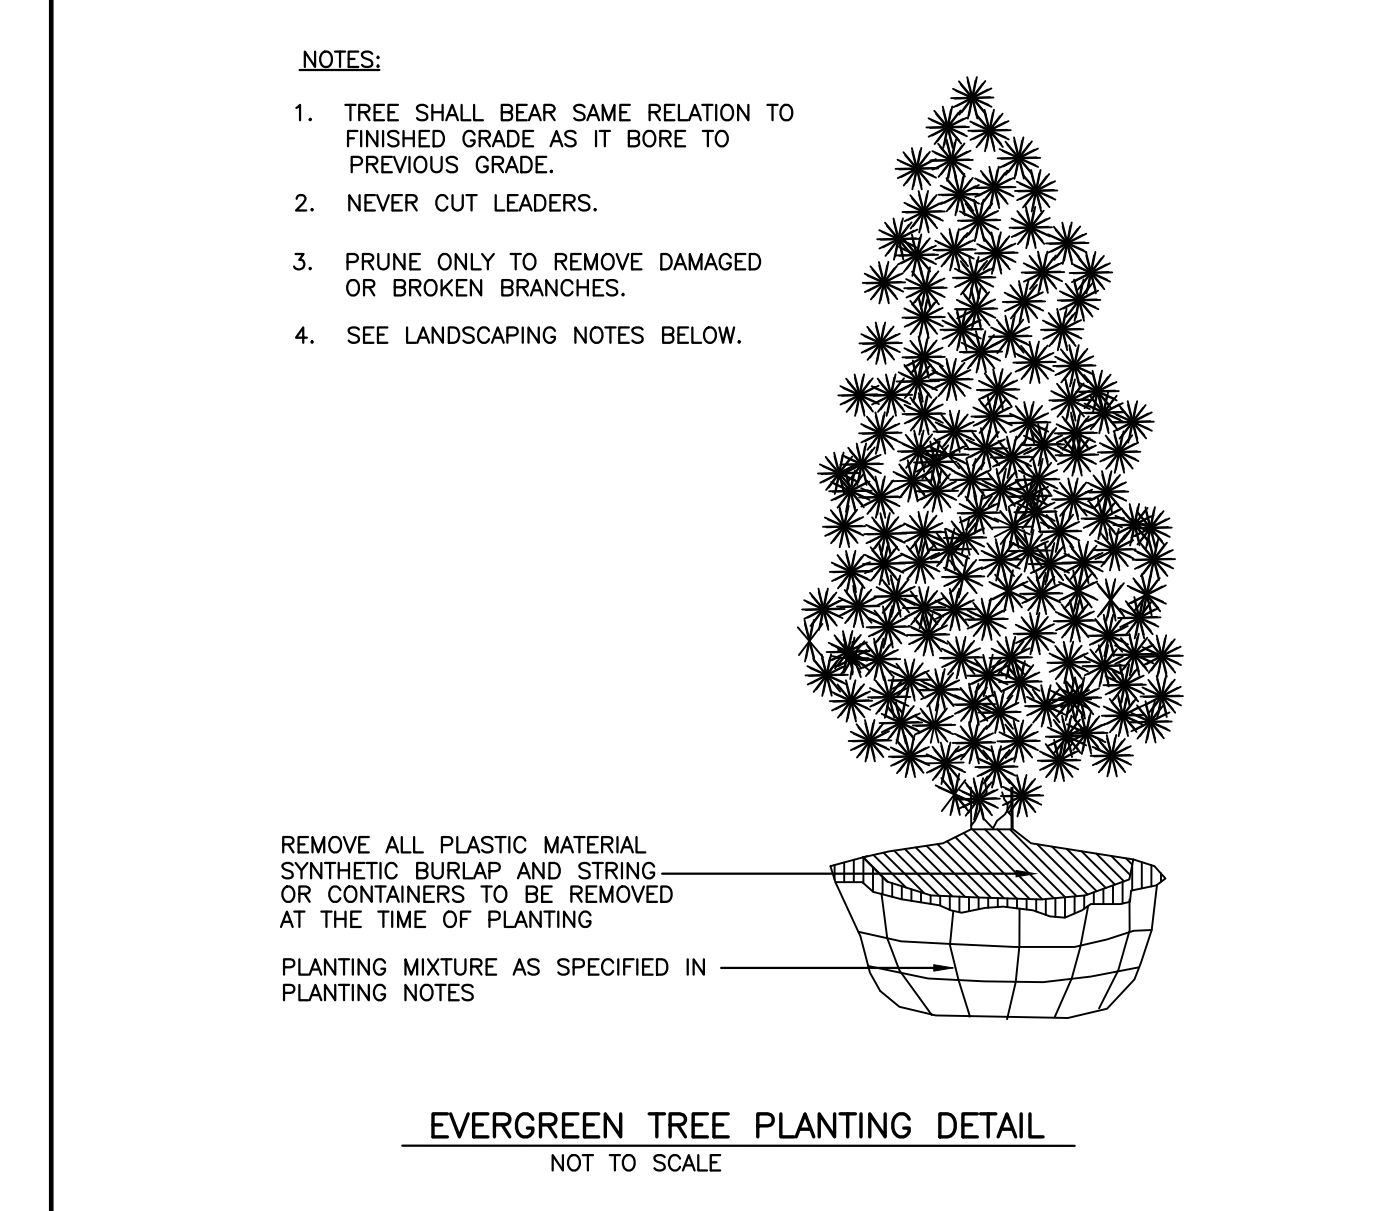Project Name
Commemorative Plaza at Ewing High School

Project Owner Name
Ewing Public Schools

Project Location
900 Parkway Avenue, Ewing, NJ 08618

Project Number
5410

Project Date
06/16/2022

Checked By
WBE (EEG)

Drawn By
SRP (EEG)

Scale
AS NOTED

Drawing Name
LANDSCAPING PLAN PLAZA AREA

Revisions

No.	Date	Description

Drawing Number
C7.0